

GREEN BAY MCDONALD NCRF RESTORATION PROJECT

60% DESIGN DRAFT

10/2/2025



WISCONSIN STATE MAP
(NOT TO SCALE)



SOURCE:
BROWN COUNTY GIS

PROJECT AREA
(NOT TO SCALE)

Sheet List Table

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3	C-2	Construction Access Plan
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12	C-11	Habitat Restoration Sections (2 of 3)
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21	D-2	Details

PREPARED FOR:

CITY OF GREEN BAY
100 N. JEFFERSON ST.
GREEN BAY, WI 54301
(920) 448-3000

PREPARED BY:

GEI CONSULTANTS, INC.
3159 VOYAGER DRIVE
GREEN BAY, WI 54311
(920)455-8200



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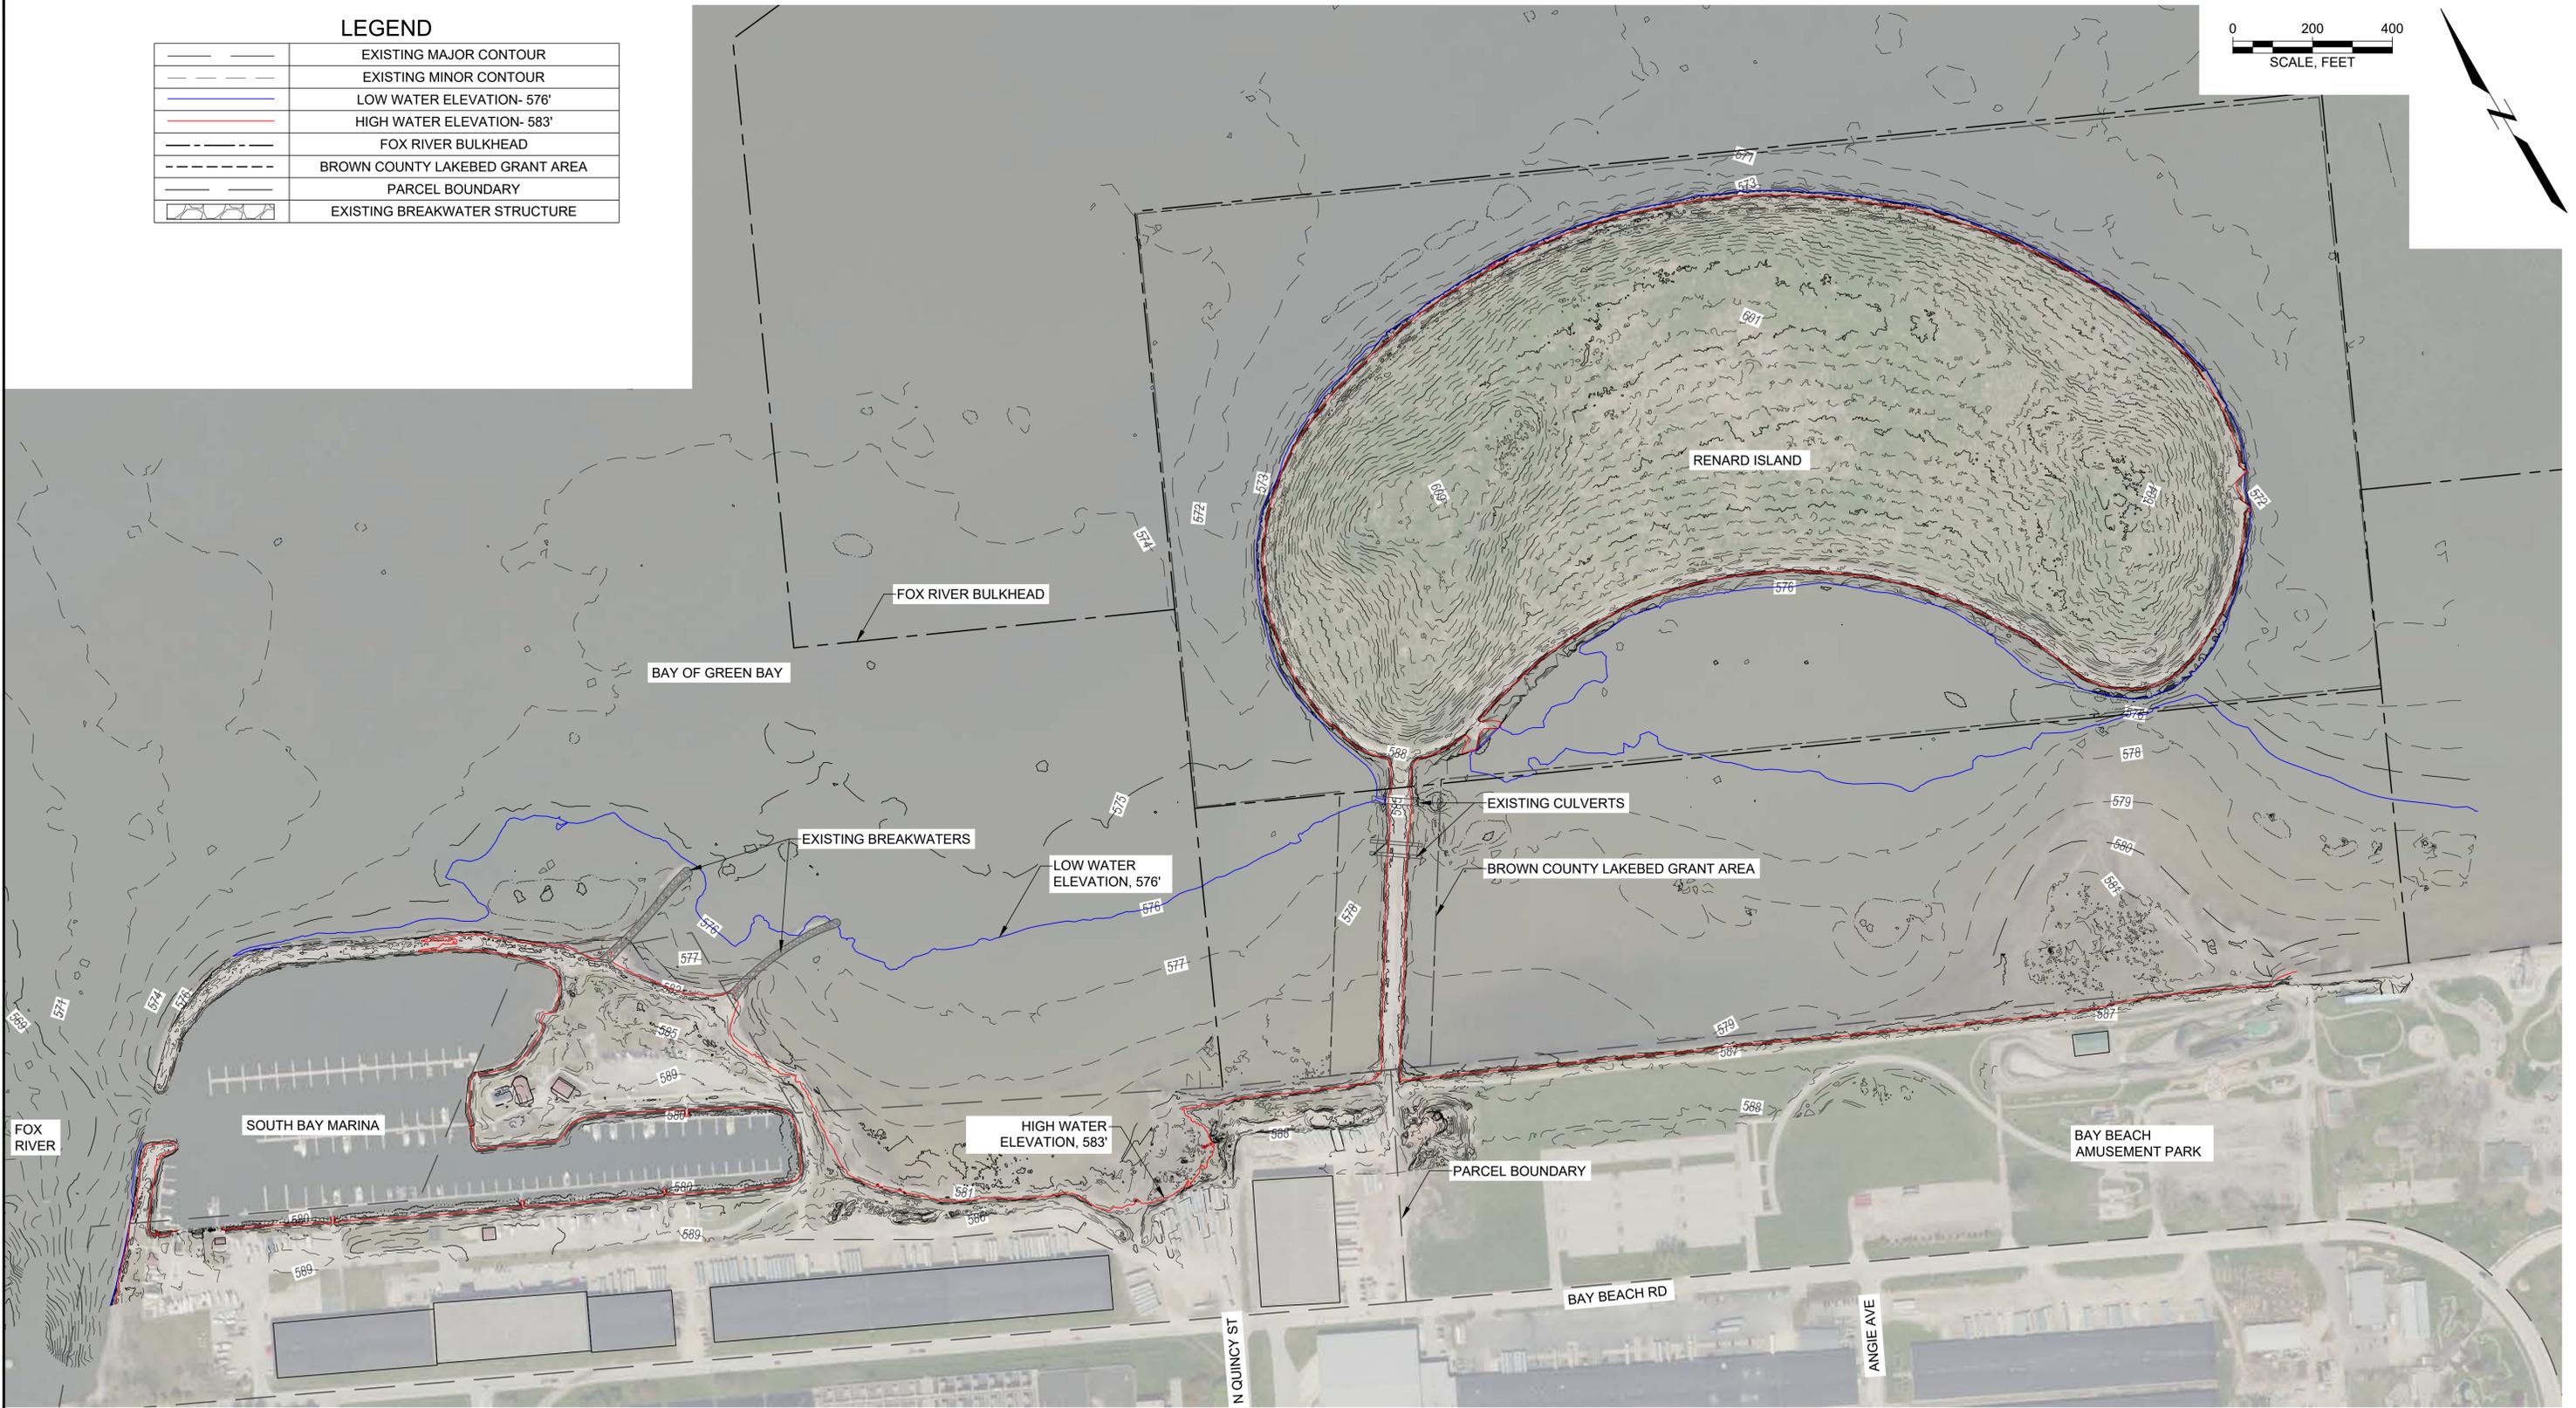
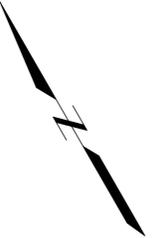
GEI PROJECT NO. 2400860

PROGRESS 60%

				DRAFT	SHEET NO. 1
3	10/2/2025	60% DESIGN DRAFT	AT		
2	3/11/2025	60% DESIGN DRAFT	AT		
1	2/7/2025	PRELIMINARY DESIGN	AT		
NO.	DATE	ISSUE/REVISION	APP		

LEGEND

	EXISTING MAJOR CONTOUR
	EXISTING MINOR CONTOUR
	LOW WATER ELEVATION- 576'
	HIGH WATER ELEVATION- 583'
	FOX RIVER BULKHEAD
	BROWN COUNTY LAKEBED GRANT AREA
	PARCEL BOUNDARY
	EXISTING BREAKWATER STRUCTURE



LURD, ASHLEY @ Working GREEN BAY WI CITY OF GREEN BAY NCRF Restoration00_CADD\Design\Sheets\Existing Conditions Plan.dwg - 9/29/2025

PROGRESS 60%

- REFERENCE NOTES:**
- DRAWING COORDINATE SYSTEM: WISCONSIN COORDINATE REFERENCE SYSTEM, BROWN COUNTY, NORTH AMERICAN DATUM 1983 (NAD83), U.S. SURVEY FEET.
 - DRAWING VERTICAL DATUM: NORTH AMERICAN VERTICAL DATUM OF 1988 (NAVD88).
 - ADD 0.443' TO IGLD85 ELEVATIONS TO CONVERT TO NAVD88.
 - HIGH WATER ELEVATION AND LOW WATER ELEVATION SOURCE: UNITED STATES ARMY CORPS OF ENGINEERS (USACE) NATIONAL OCEANIC AND ATMOSPHERIC ADMINISTRATION (NOAA).

Attention:

 If this scale bar does not measure 1" then drawing is not original scale.

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 GEI Project 2400860

CITY OF GREEN BAY
 100 N. JEFFERSON ST.
 GREEN BAY, WI 54301

GREEN BAY MCDONALD NCRF RESTORATION PROJECT

GREEN BAY, WI 54302


NO	DATE	ISSUE/REVISION	APP
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2	3/11/2025	60% DESIGN DRAFT	AT
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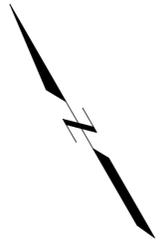
SHEET NAME
Existing Conditions Plan

SHEET NO.
2 OF 21

DWG. NO.
C-1

LEGEND

	CONSTRUCTION ACCESS ROAD
	OVERALL PROJECT AREA
	STAGING AREA
	BARGE ACCESS

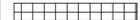

PROGRESS 60%

NOTES:
1. STAGING AREA AND BARGE ACCESS LOCATIONS ARE SUBJECT TO LANDOWNER APPROVAL AND SEASONAL OPERATIONS.

<p>Attention:</p>  <p>If this scale bar does not measure 1" then drawing is not original scale.</p>	DRAFT	Designed:
		Drawn:
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1	2/7/2025	PRELIMINARY DESIGN	AT

SHEET NAME
Construction Access Plan

SHEET NO.



3 OF 21

DWG. NO.

C-2

LEGEND

	EXISTING MAJOR CONTOUR
	EXISTING MINOR CONTOUR
	LOW WATER ELEVATION- 576'
	HIGH WATER ELEVATION- 583'
	FOX RIVER BULKHEAD
	BROWN COUNTY LAKEBED GRANT AREA
	PARCEL BOUNDARY
	EXISTING BREAKWATER STRUCTURE
	TURBIDITY CURTAIN
	STONE REMOVAL AREA

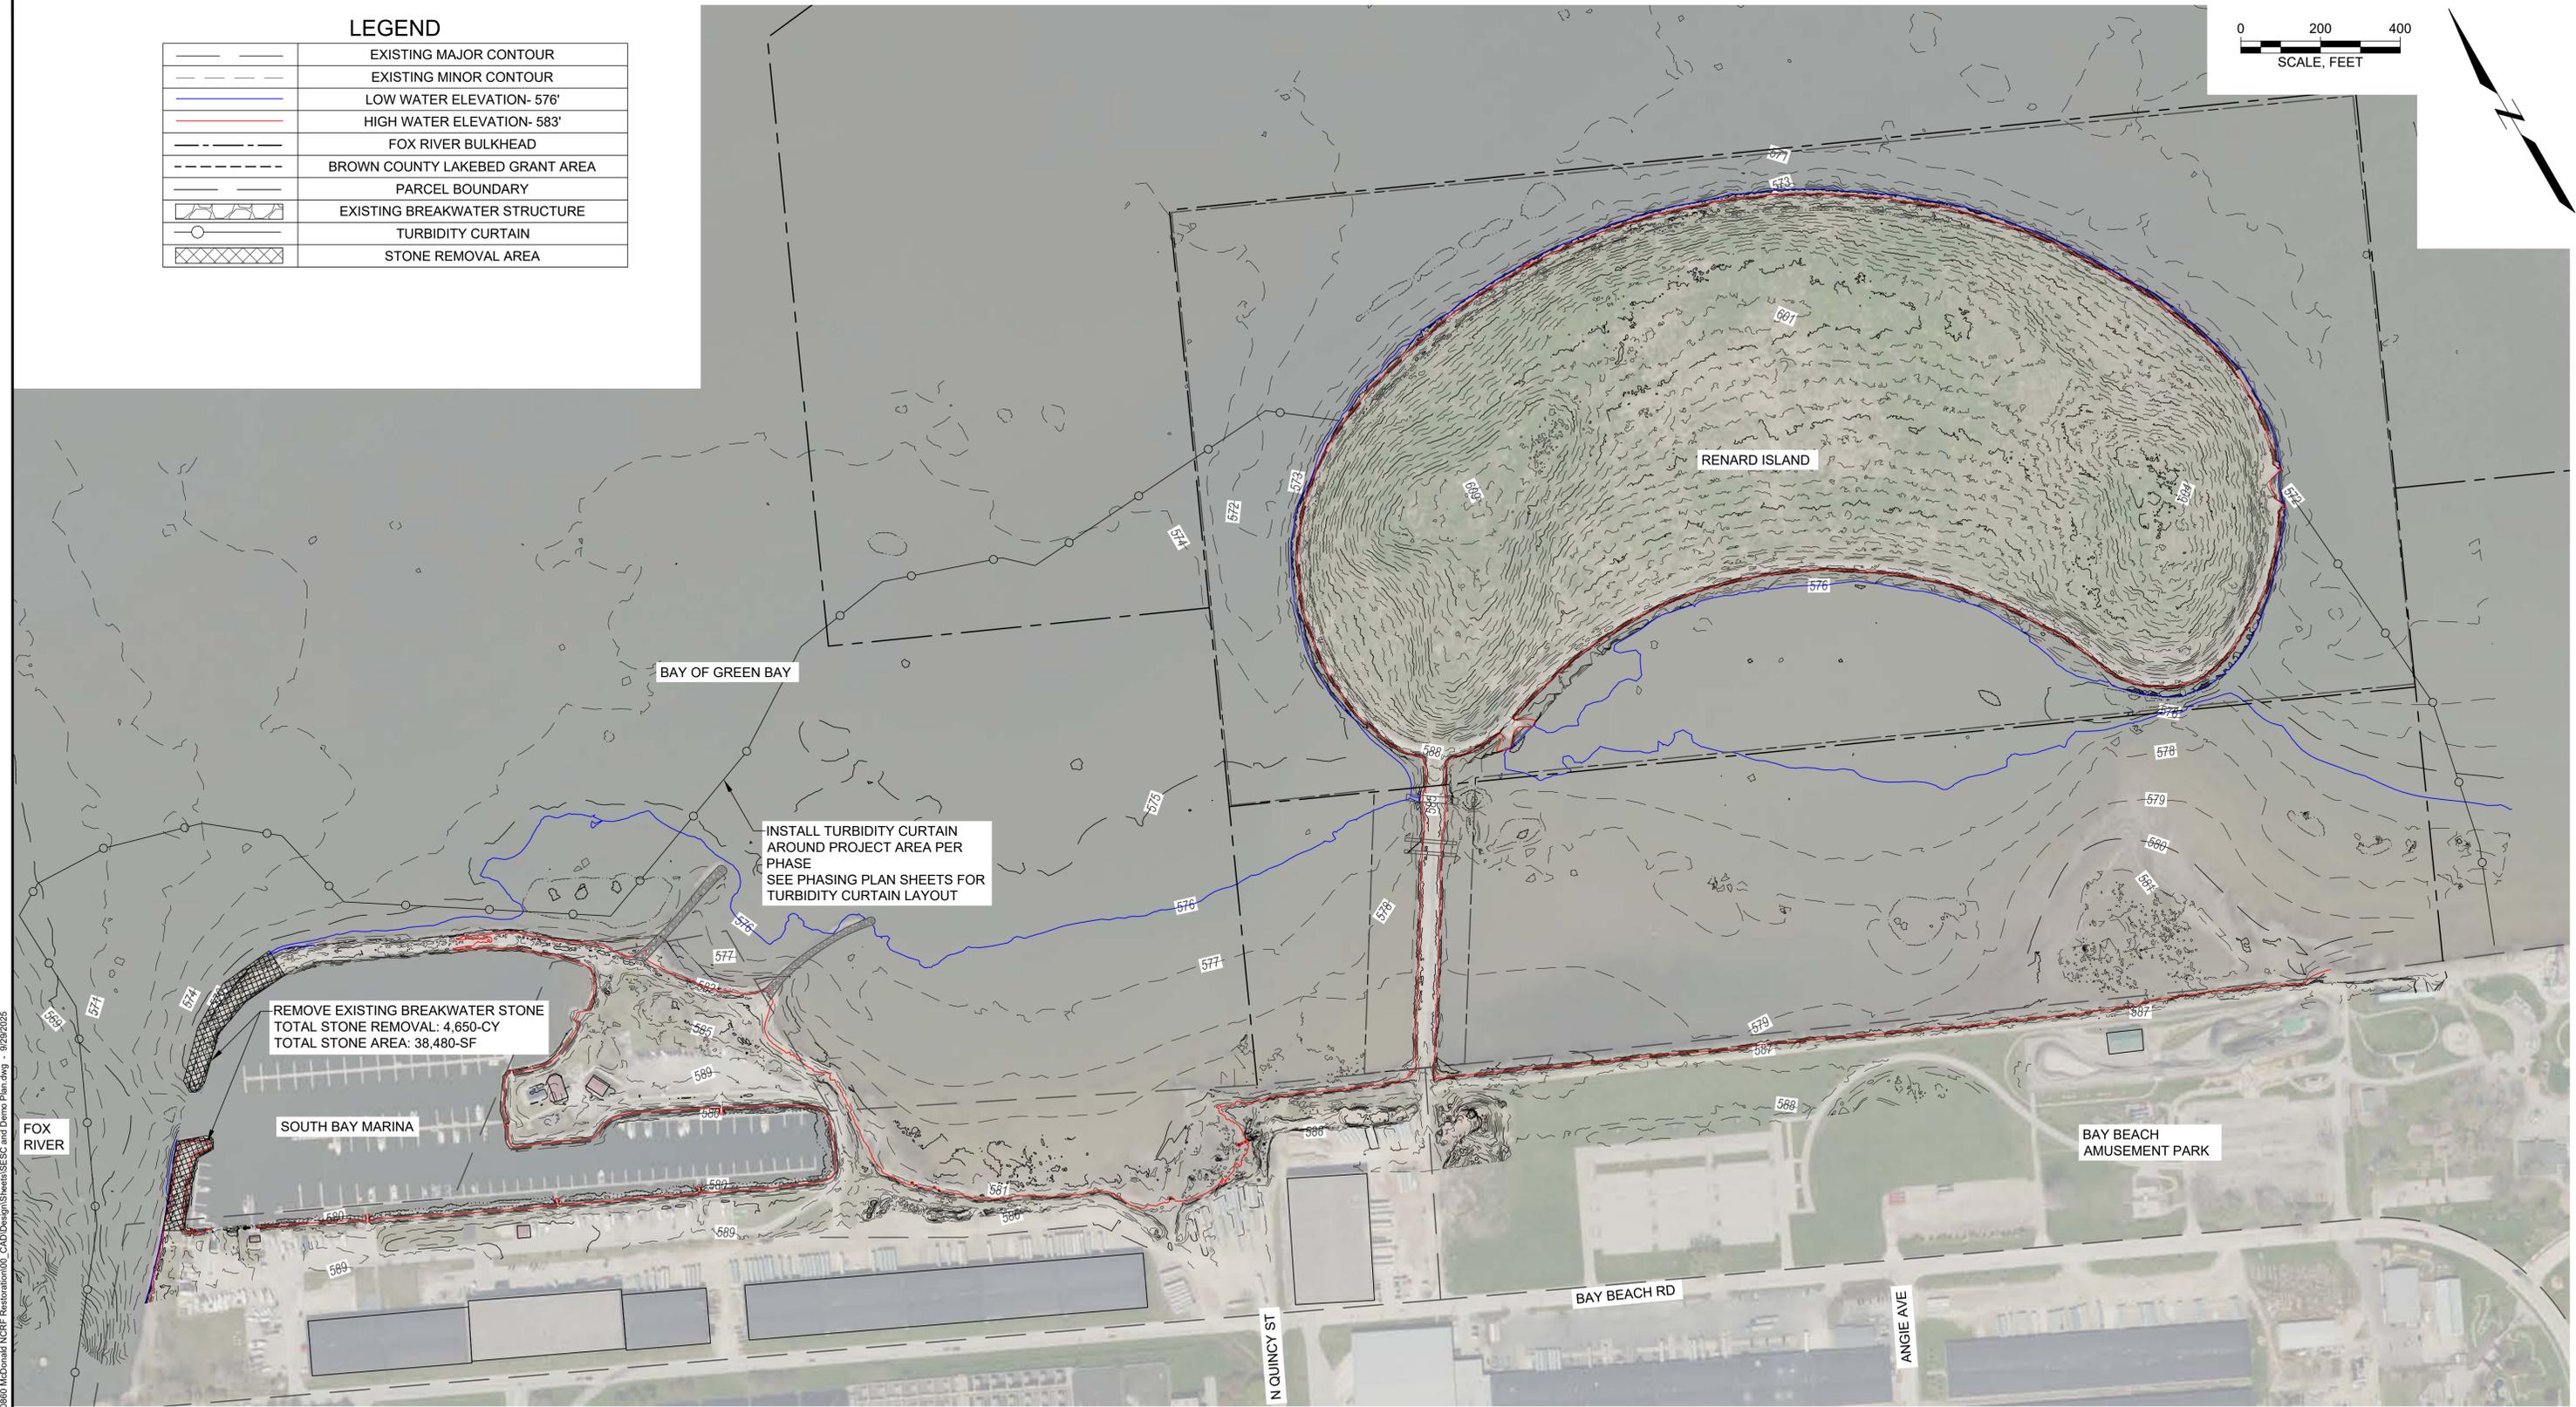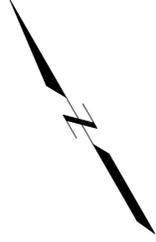


REMOVE EXISTING BREAKWATER STONE
TOTAL STONE REMOVAL: 4,650-CY
TOTAL STONE AREA: 38,480-SF

INSTALL TURBIDITY CURTAIN
AROUND PROJECT AREA PER
PHASE
SEE PHASING PLAN SHEETS FOR
TURBIDITY CURTAIN LAYOUT

LJURD, ASHLEY @ Working GREEN BAY WI CITY OF GREEN BAY NCRF Restoration100_CAD\Design\Sheets\SESC and Demolition Plan.dwg - 9/29/2025

PROGRESS 60%

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GEI Project	2400860

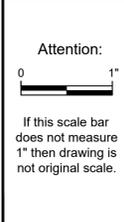CITY OF GREEN BAY
100 N. JEFFERSON ST.
GREEN BAY, WI 54301

GREEN BAY MCDONALD NCRF RESTORATION PROJECT


GREEN BAY, WI 54302

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SHEET NAME
SESC and Demolition Plan


SHEET NO.
4 OF 21

DWG. NO.
C-3

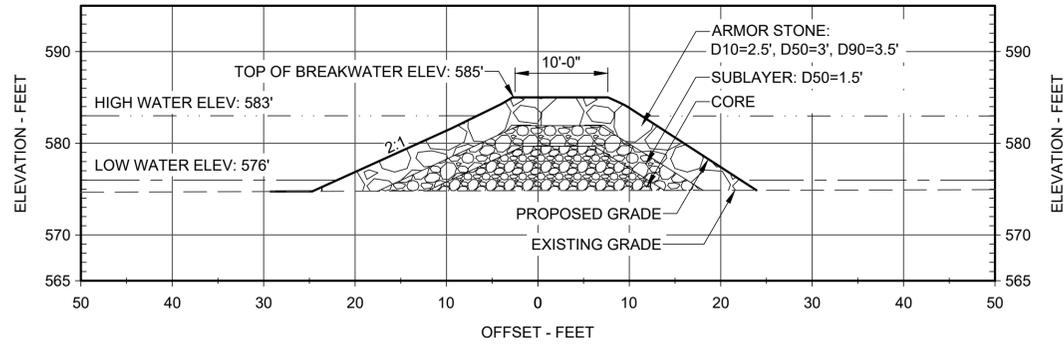


C-4 SECTION A-A'
WESTERN BREAKWATER EXTENSION

SCALE: 1" = 10'

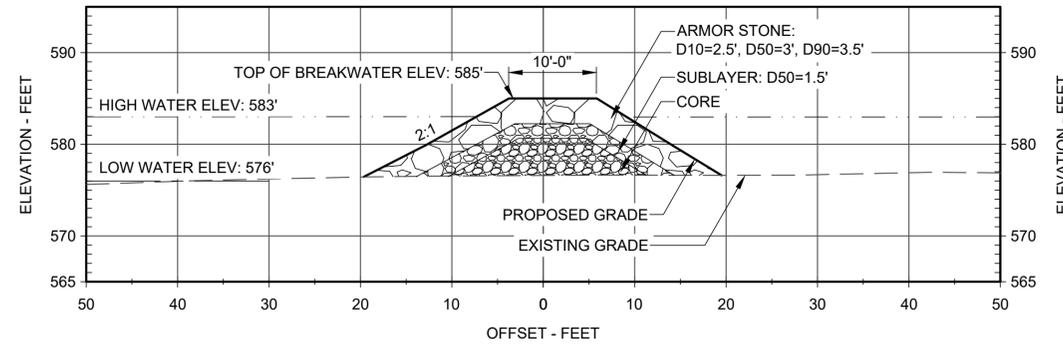


C-4 SECTION B-B'
EASTERN BREAKWATER EXTENSION

SCALE: 1" = 10'

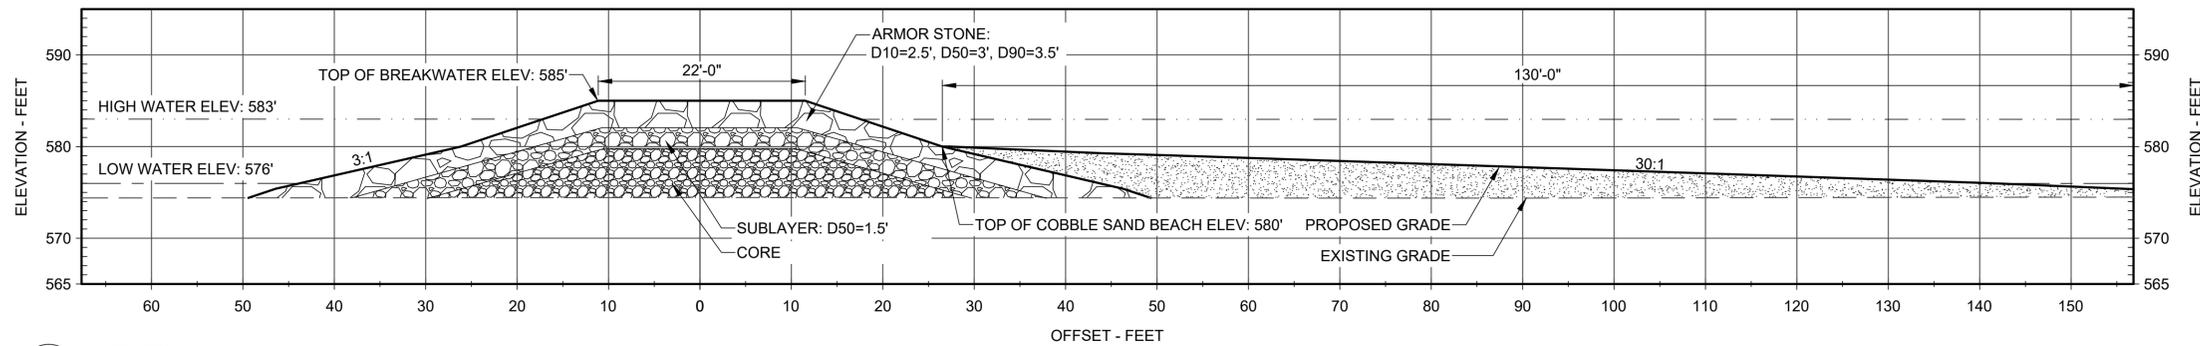


C-4 SECTION C-C'
CENTRAL HABITAT ISLAND BREAKWATER AND COBBLE SAND BEACH PUBLIC ACCESS

SCALE: 1" = 10'

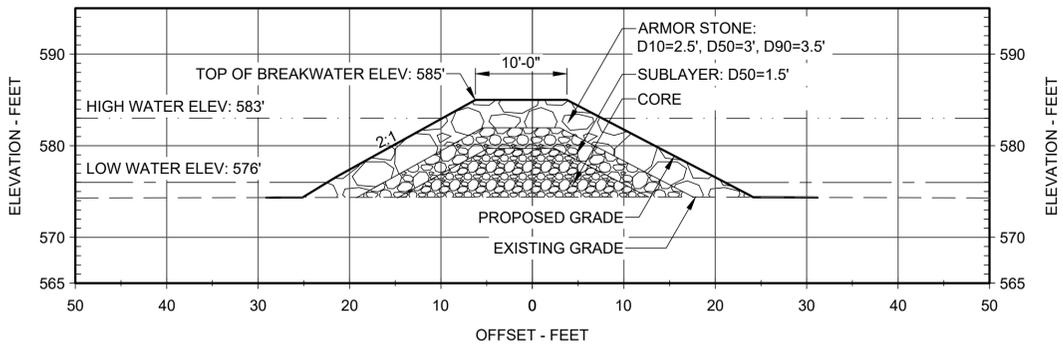

C-4 SECTION D-D'
TRIANGULAR BREAKWATER

SCALE: 1" = 10'

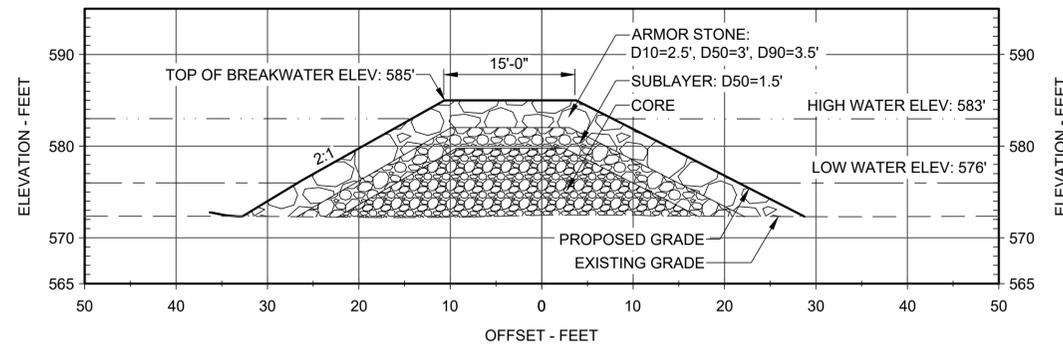


C-4 SECTION E-E'
EASTERN HABITAT ISLAND BREAKWATER

SCALE: 1" = 10'

LEGEND

	EXISTING GRADE
	PROPOSED GRADE
	LOW WATER ELEVATION
	HIGH WATER ELEVATION

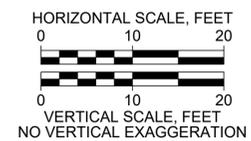

PROGRESS 60%

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GEI Project 2400860

CITY OF GREEN BAY
100 N. JEFFERSON ST.
GREEN BAY, WI 54301


GREEN BAY MCDONALD NCRF RESTORATION PROJECT

GREEN BAY, WI 54302


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SHEET NAME
Breakwater Sections (1 of 3)


SHEET NO.
7 OF 21
DWG. NO.
C-6

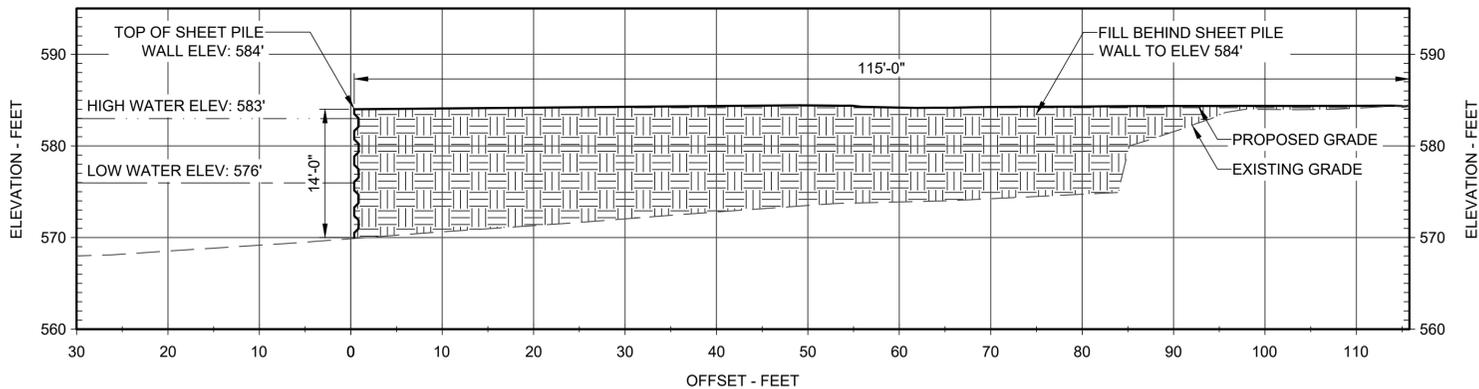

C-5 SECTION F-F'
SHEET PILE WALL
SCALE: 1" = 10'

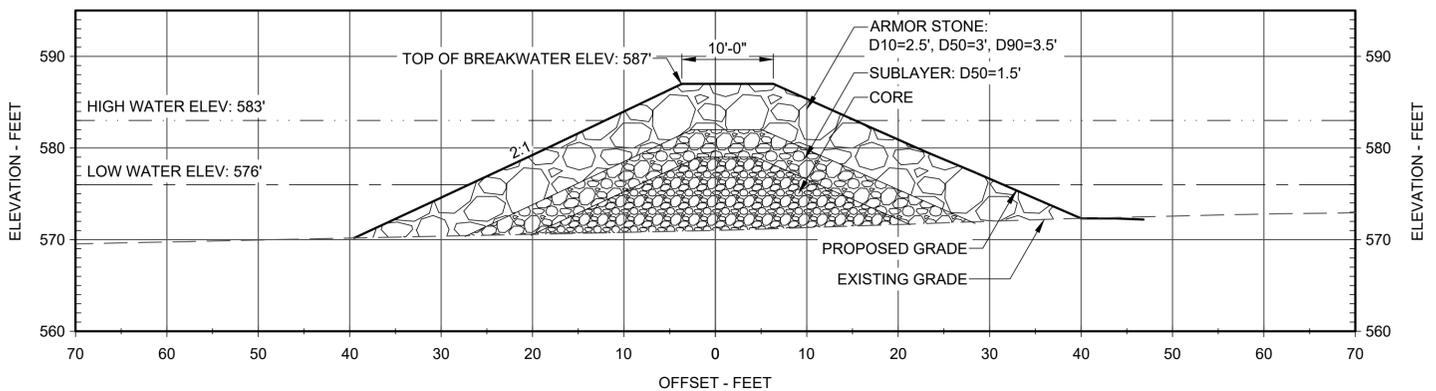


C-5 SECTION G-G'
SOUTHWEST MARINA BREAKWATER
SCALE: 1" = 10'

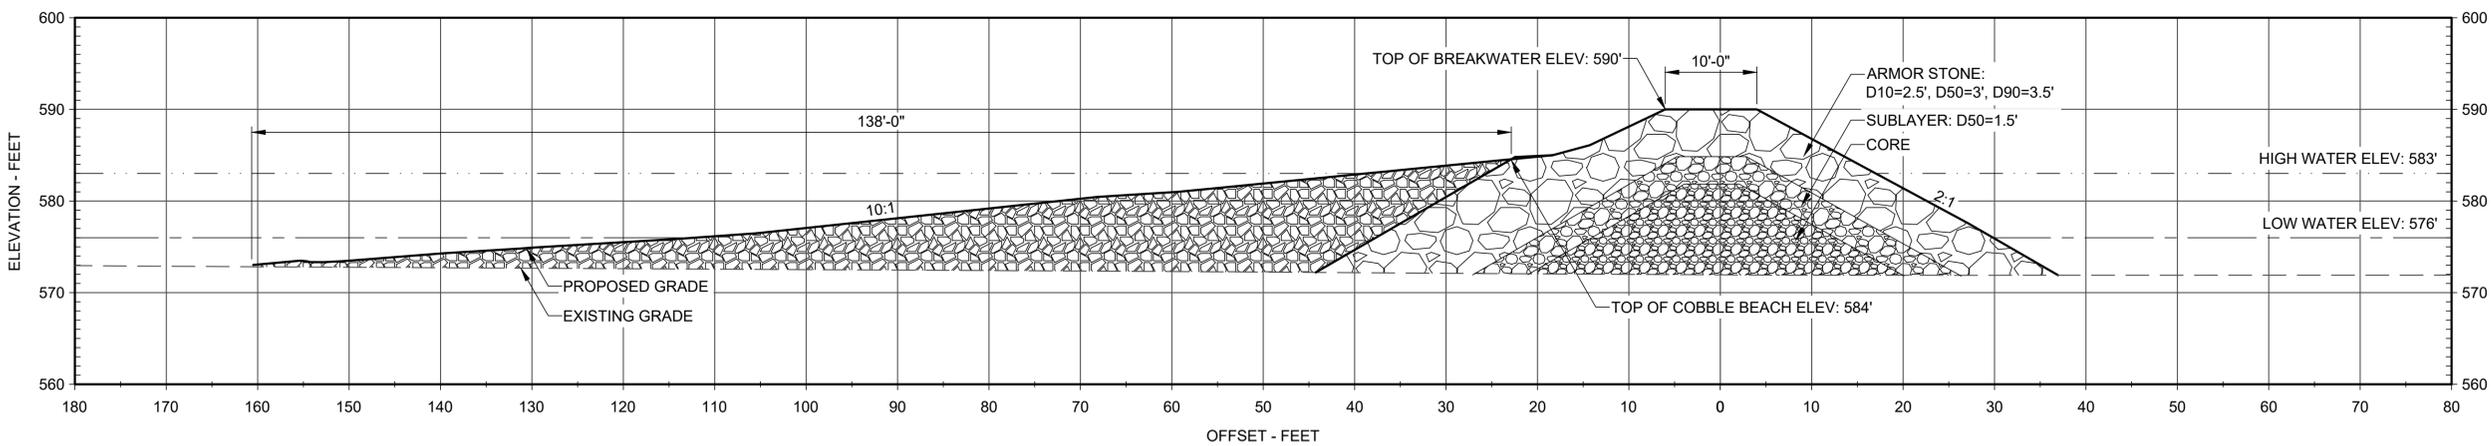

C-5 SECTION H-H'
NORTH MARINA BREAKWATER AND WAVE ABSORBING COBBLE BEACH
SCALE: 1" = 10'

LEGEND


	EXISTING GRADE
	PROPOSED GRADE
	LOW WATER ELEVATION
	HIGH WATER ELEVATION

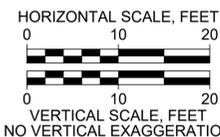

PROGRESS 60%


Attention: If this scale bar does not measure 1" then drawing is not original scale.	<h1>DRAFT</h1>	Designed:	CITY OF GREEN BAY 100 N. JEFFERSON ST. GREEN BAY, WI 54301	GREEN BAY MCDONALD NCRF RESTORATION PROJECT	3 10/2/2025 60% DESIGN DRAFT AT 2 3/11/2025 60% DESIGN DRAFT AT 1 2/7/2025 PRELIMINARY DESIGN AT NO DATE ISSUE/REVISION APP	SHEET NAME	SHEET NO.
		Drawn:				Breakwater Sections (2 of 3)	8 OF 21
Checked:	DWG. NO.						
Approved:	C-7						
P.E. No:							
GEI Project 2400860							

I:\URD_ASHLEY_B\Working\GREEN BAY WI CITY OF\2400860 McDonald NCRF Restoration\100_CAD\Design\Sheet\Breakwater Sections.dwg - 9/29/2025

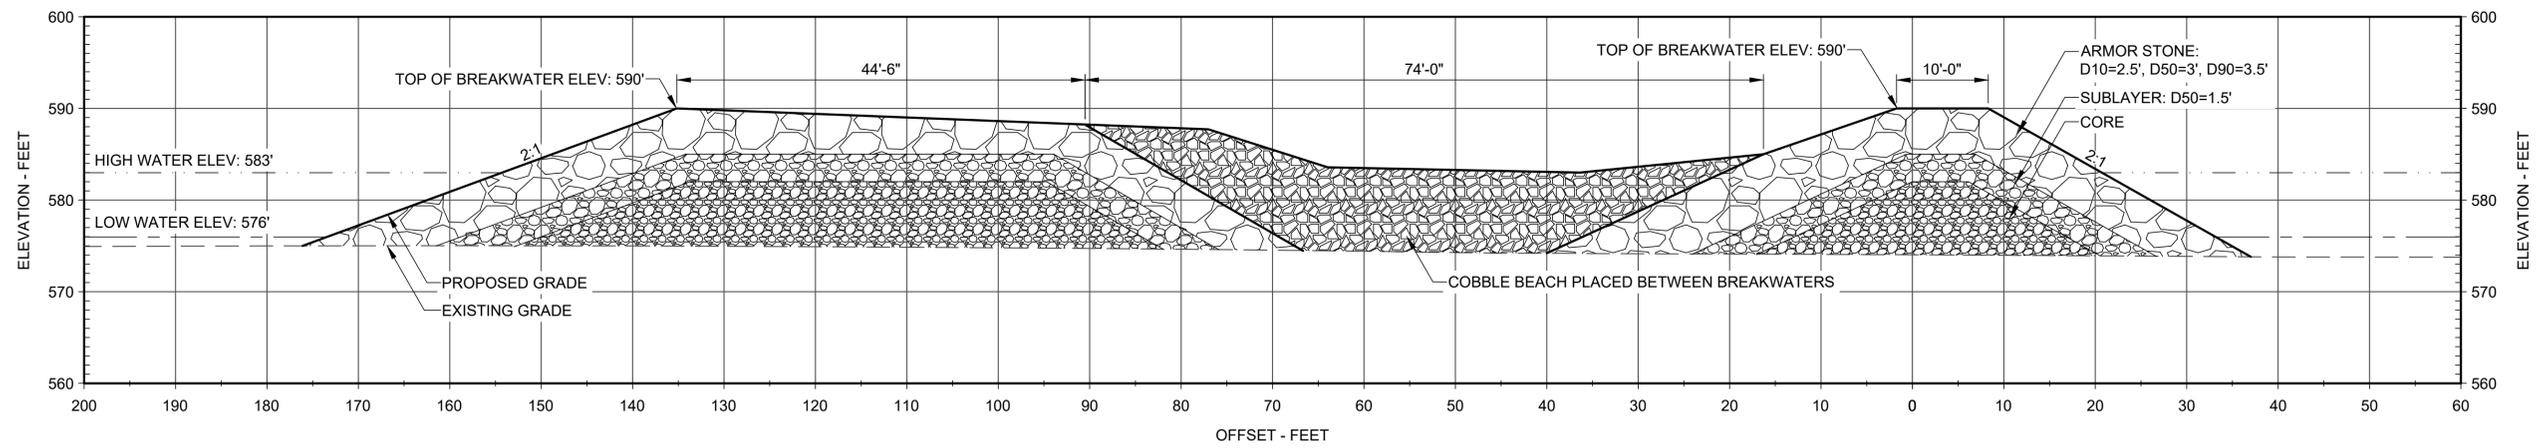


C-5 SECTION I-I'
NORTH MARINA BREAKWATER

SCALE: 1" = 10'

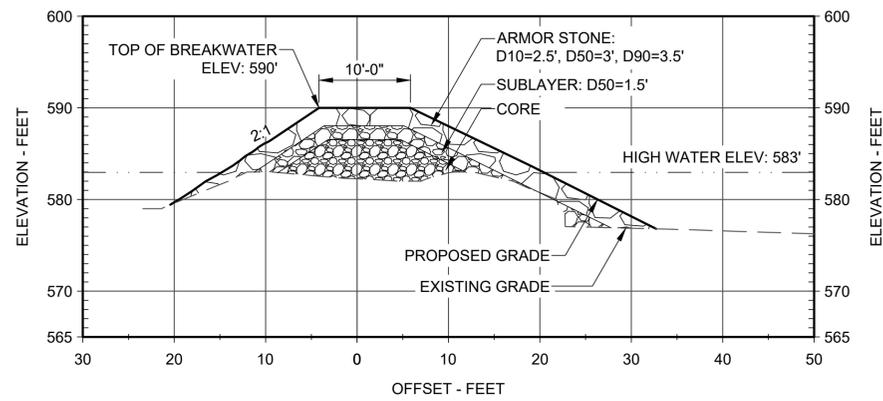

C-5 SECTION J-J'
NORTH MARINA BREAKWATER

SCALE: 1" = 10'

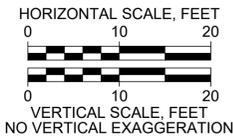

LEGEND

	EXISTING GRADE
	PROPOSED GRADE
	LOW WATER ELEVATION
	HIGH WATER ELEVATION

PROGRESS 60%

Attention:

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 Approved: _____
 P.E. No: _____
 GEI Project 2400860

CITY OF GREEN BAY
 100 N. JEFFERSON ST.
 GREEN BAY, WI 54301

GREEN BAY MCDONALD NCRF RESTORATION PROJECT

GREEN BAY, WI 54302

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2	3/11/2025	60% DESIGN DRAFT	AT
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SHEET NAME
Breakwater Sections (3 of 3)

SHEET NO.




9 OF 21

DWG. NO.

C-8

LEGEND

	EXISTING MAJOR CONTOUR
	EXISTING MINOR CONTOUR
	PROPOSED MAJOR CONTOUR
	PROPOSED MINOR CONTOUR
	PROPOSED GRADING EXTENTS
	LOW WATER ELEVATION- 576'
	HIGH WATER ELEVATION- 583'
	FOX RIVER BULKHEAD
	BROWN COUNTY LAKEBED GRANT AREA
	PARCEL BOUNDARY
	PROPOSED BREAKWATER STRUCTURE
	PROPOSED COBBLE SAND BEACH
	PROPOSED BOARDWALK AND GATHERING CIRCLE
	PROPOSED CONCRETE PAVED PATH
	PROPOSED COBBLE OUTCROP
	GREAT LAKES BEACH- 577'-582'
	SHRUB CARR- 580'-582'
	WET MEADOW- 580'-582'
	EMERGENT MARSH (HIGH ENERGY COASTAL)- 578'-580'
	SUBMERGENT MARSH (HIGH ENERGY COASTAL)- 577'-578'

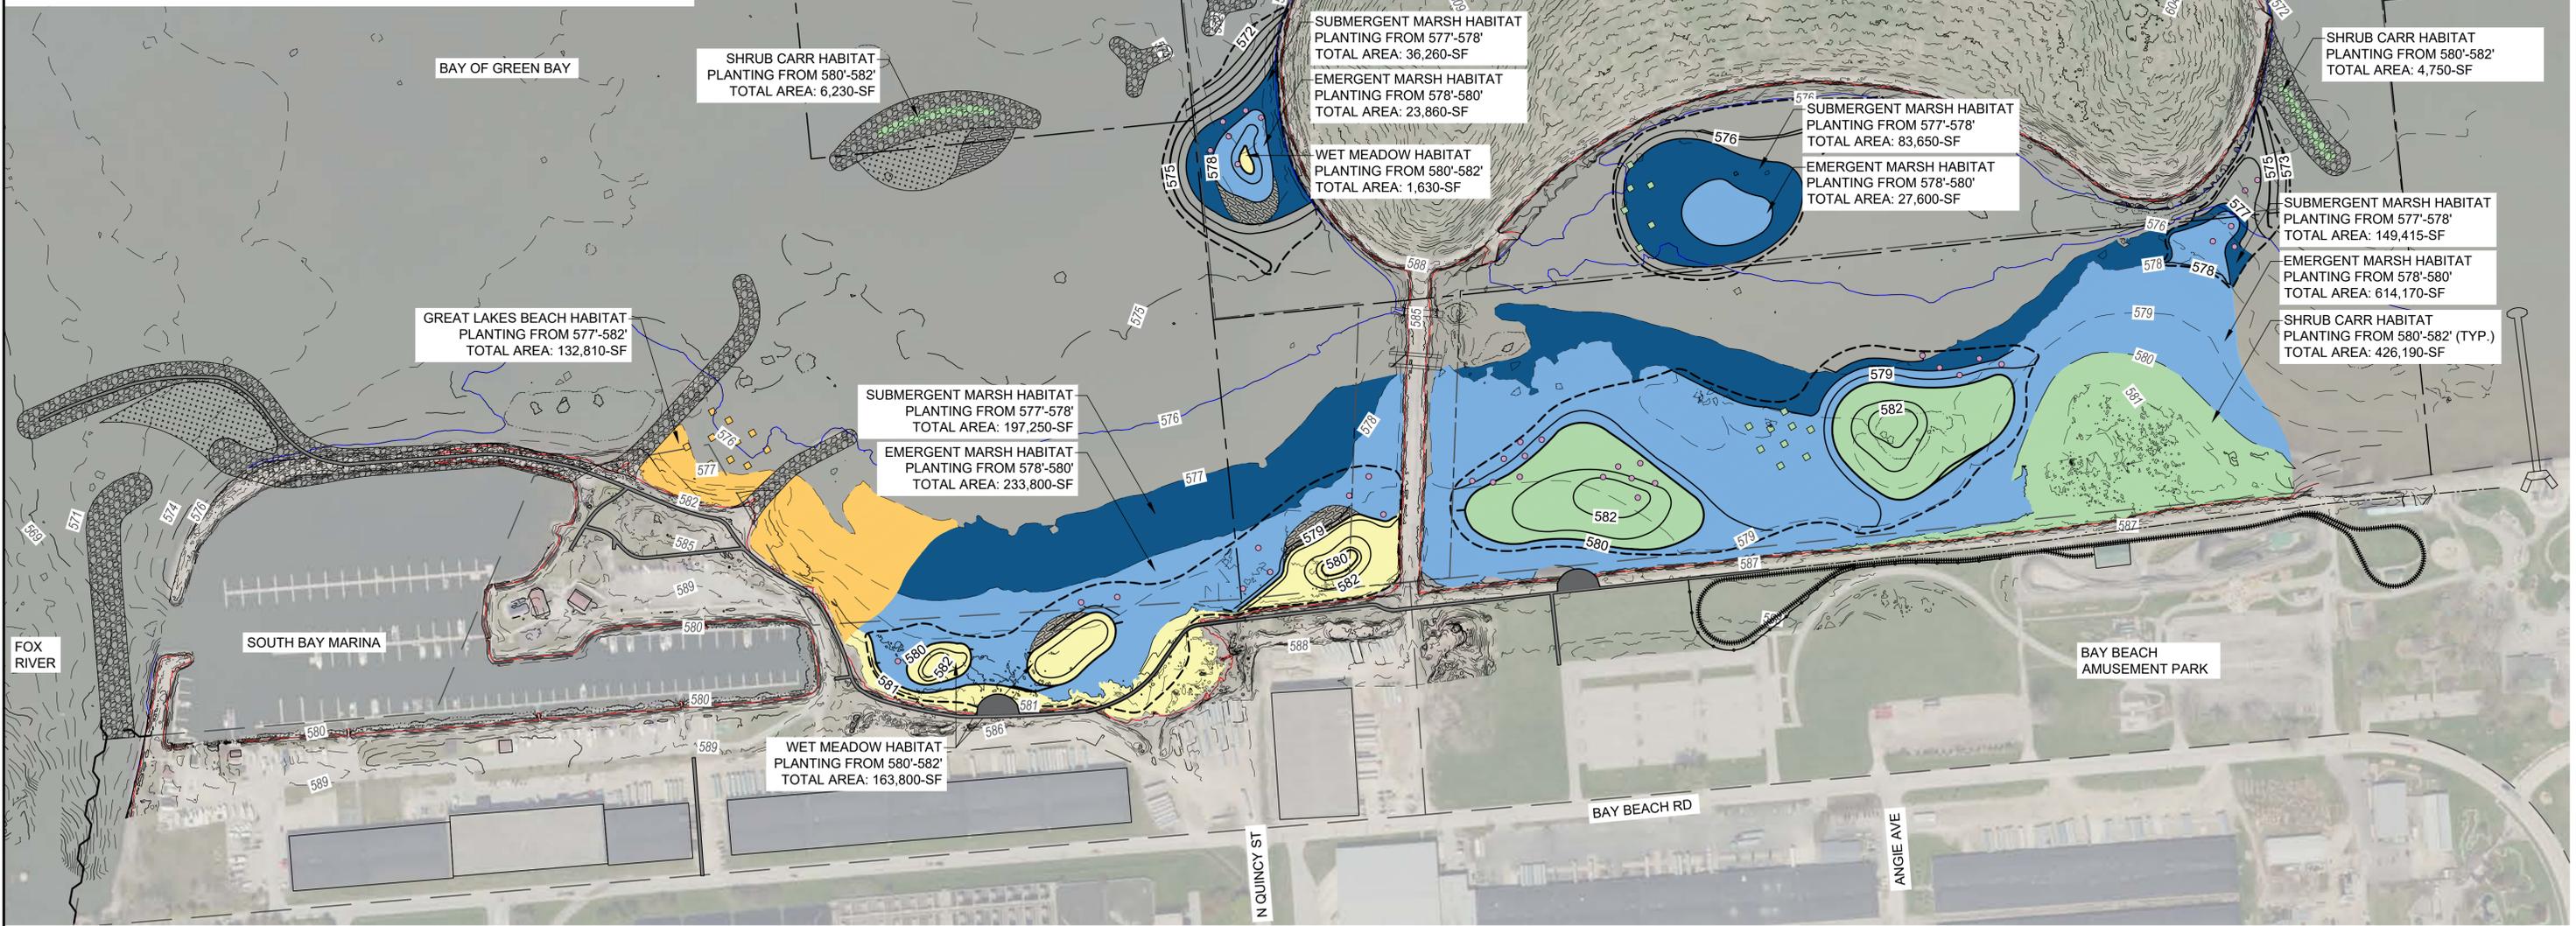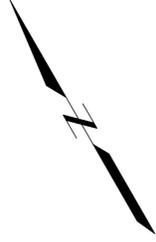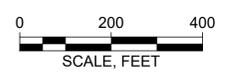

JURD, ASHLEY @ WorkingGREEN BAY WI, CITY OF GREEN BAY NCRF Restoration Planning Plan, Aug - 02/2025

NOTES:
 1. SEE PLANT LISTS ON SHEET D-1 FOR ALL HABITAT PLANTINGS.

Attention:

If this scale bar does not measure 1" then drawing is not original scale.

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Approved:	
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GEI Project	2400860

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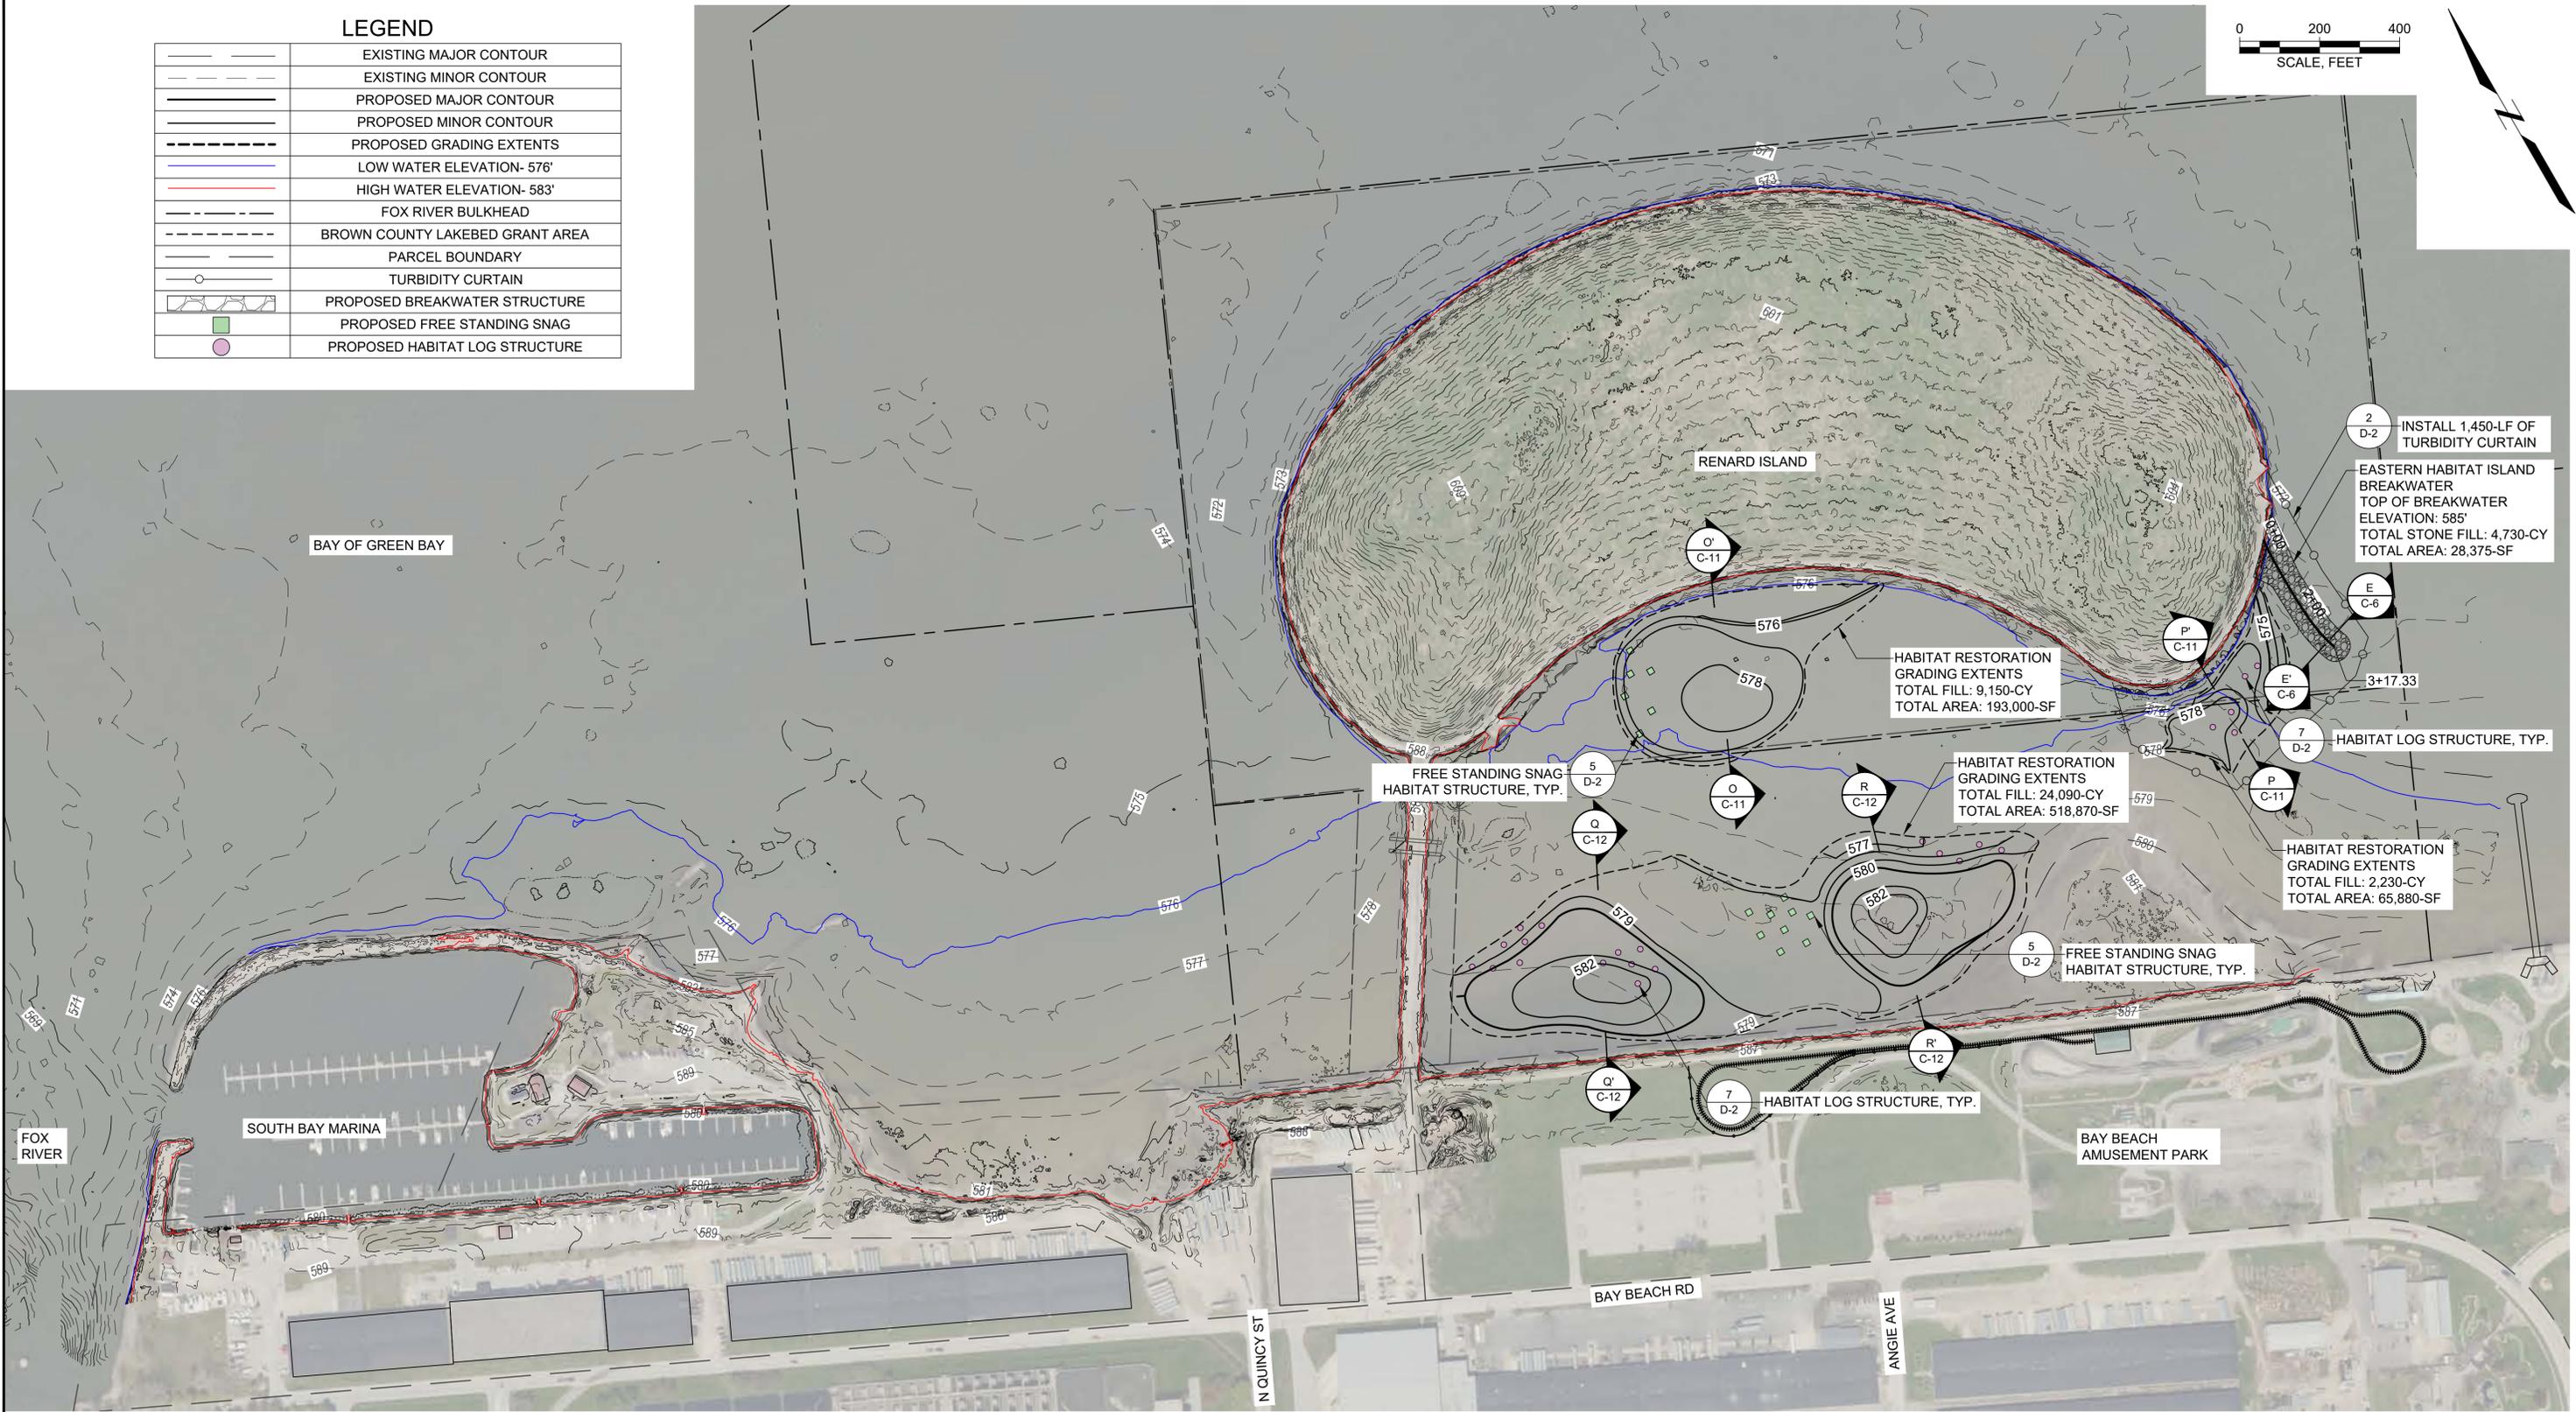
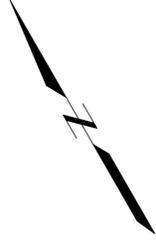
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1	2/7/2025	PRELIMINARY DESIGN	AT

SHEET NAME	SHEET NO.
Overall Habitat Restoration Planting Plan	14 OF 21
	DWG. NO.
	C-13

PROGRESS 60%

LEGEND

	EXISTING MAJOR CONTOUR
	EXISTING MINOR CONTOUR
	PROPOSED MAJOR CONTOUR
	PROPOSED MINOR CONTOUR
	PROPOSED GRADING EXTENTS
	LOW WATER ELEVATION- 576'
	HIGH WATER ELEVATION- 583'
	FOX RIVER BULKHEAD
	BROWN COUNTY LAKEBED GRANT AREA
	PARCEL BOUNDARY
	TURBIDITY CURTAIN
	PROPOSED BREAKWATER STRUCTURE
	PROPOSED FREE STANDING SNAG
	PROPOSED HABITAT LOG STRUCTURE



2 D-2 INSTALL 1,450-LF OF TURBIDITY CURTAIN

EASTERN HABITAT ISLAND BREAKWATER
TOP OF BREAKWATER ELEVATION: 585'
TOTAL STONE FILL: 4,730-CY
TOTAL AREA: 28,375-SF

HABITAT RESTORATION GRADING EXTENTS
TOTAL FILL: 9,150-CY
TOTAL AREA: 193,000-SF

HABITAT RESTORATION GRADING EXTENTS
TOTAL FILL: 24,090-CY
TOTAL AREA: 518,870-SF

HABITAT RESTORATION GRADING EXTENTS
TOTAL FILL: 2,230-CY
TOTAL AREA: 65,880-SF

FREE STANDING SNAG HABITAT STRUCTURE, TYP.

FREE STANDING SNAG HABITAT STRUCTURE, TYP.

HABITAT LOG STRUCTURE, TYP.

PROGRESS 60%

- NOTES:
1. SEE HABITAT RESTORATION PLANTING PLAN ON SHEET C-13 FOR HABITAT PLANTING AREAS IN PHASE 2.

DRAFT	Designed:	
	Drawn:	
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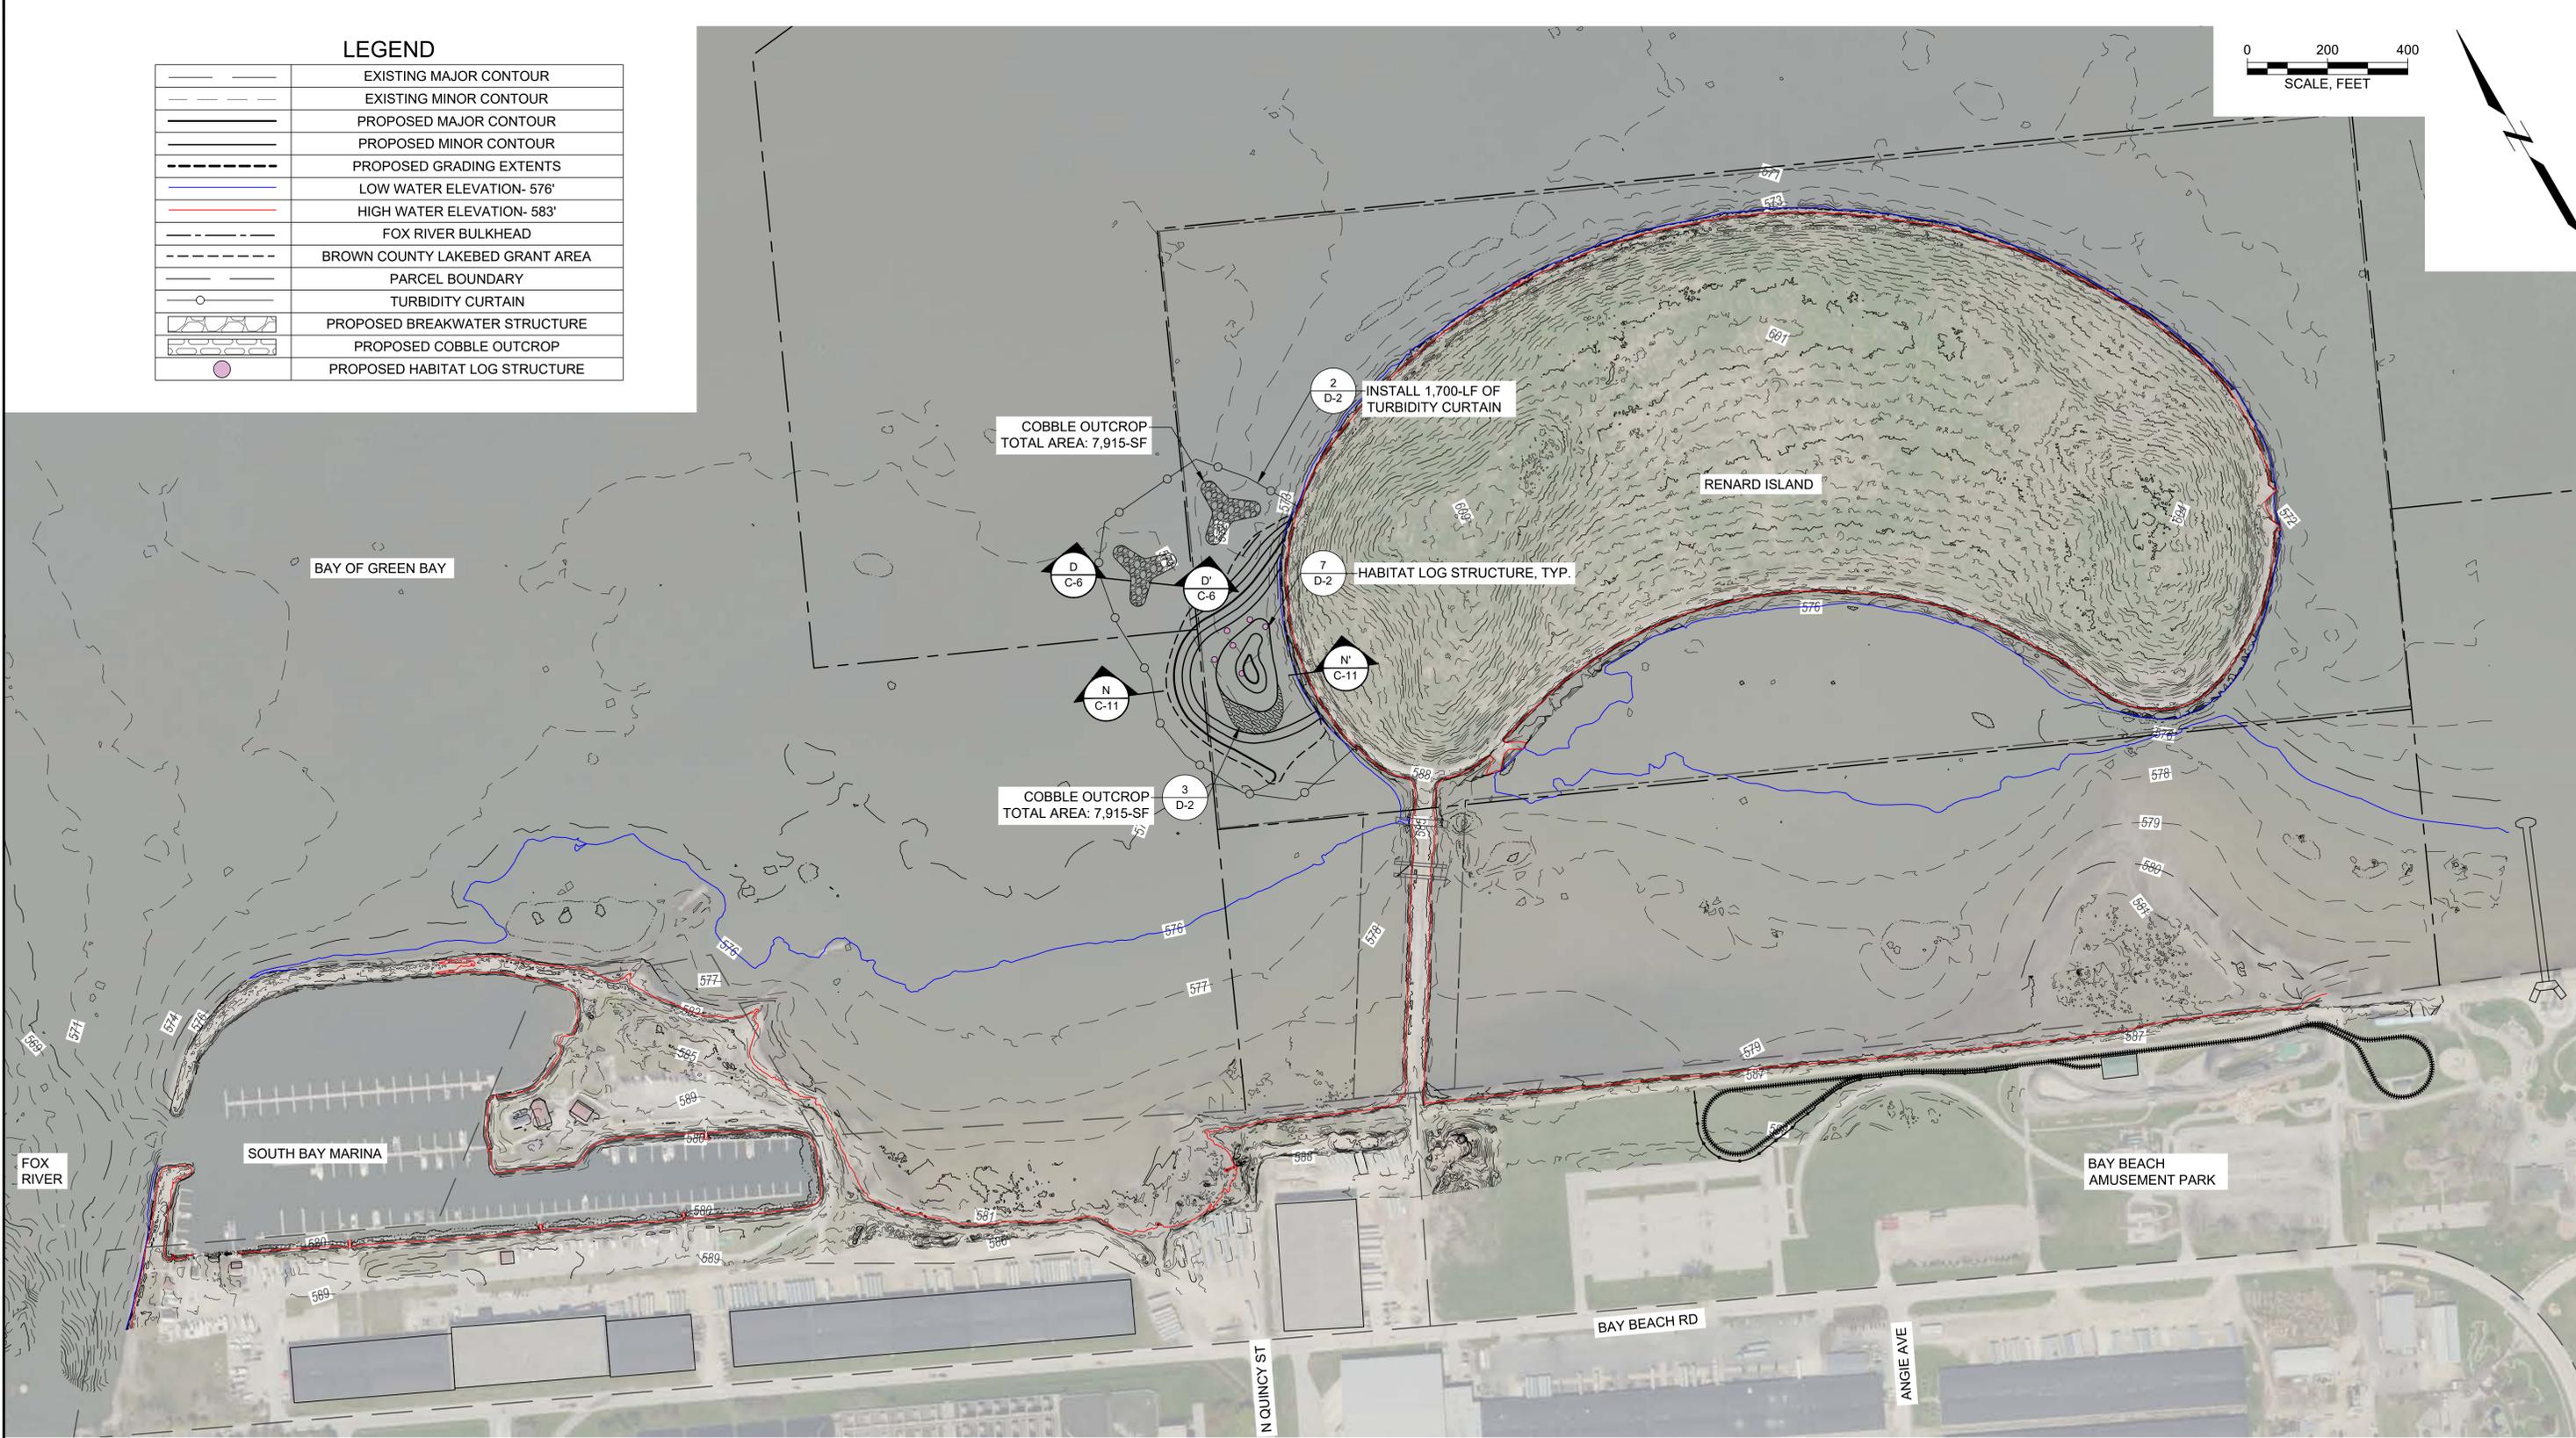
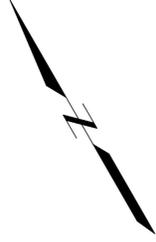
SHEET NAME
Phase 2A Breakwater and Habitat Restoration Grading Plan

SHEET NO.
15 OF 21
DWG. NO.
C-14

LURD, ASHLEY @ Working GREEN BAY WI CITY OF GREEN BAY NCRF Restoration 100_CAD Design Sheets Layout Plan Phase 2.dwg - 9/29/2025

LEGEND

	EXISTING MAJOR CONTOUR
	EXISTING MINOR CONTOUR
	PROPOSED MAJOR CONTOUR
	PROPOSED MINOR CONTOUR
	PROPOSED GRADING EXTENTS
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	TURBIDITY CURTAIN
	PROPOSED BREAKWATER STRUCTURE
	PROPOSED COBBLE OUTCROP
	PROPOSED HABITAT LOG STRUCTURE



LURD, ASHLEY @ Working GREEN BAY WI, CITY OF GREEN BAY NCRF Restoration 100, CAD/Design/Sheet/Layout/Plan, Phase 2B.dwg - 02/20/2025

NOTES:
1. SEE HABITAT RESTORATION PLANTING PLAN ON SHEET C-13 FOR HABITAT PLANTING AREAS IN PHASE 2.

Attention:
0 1"

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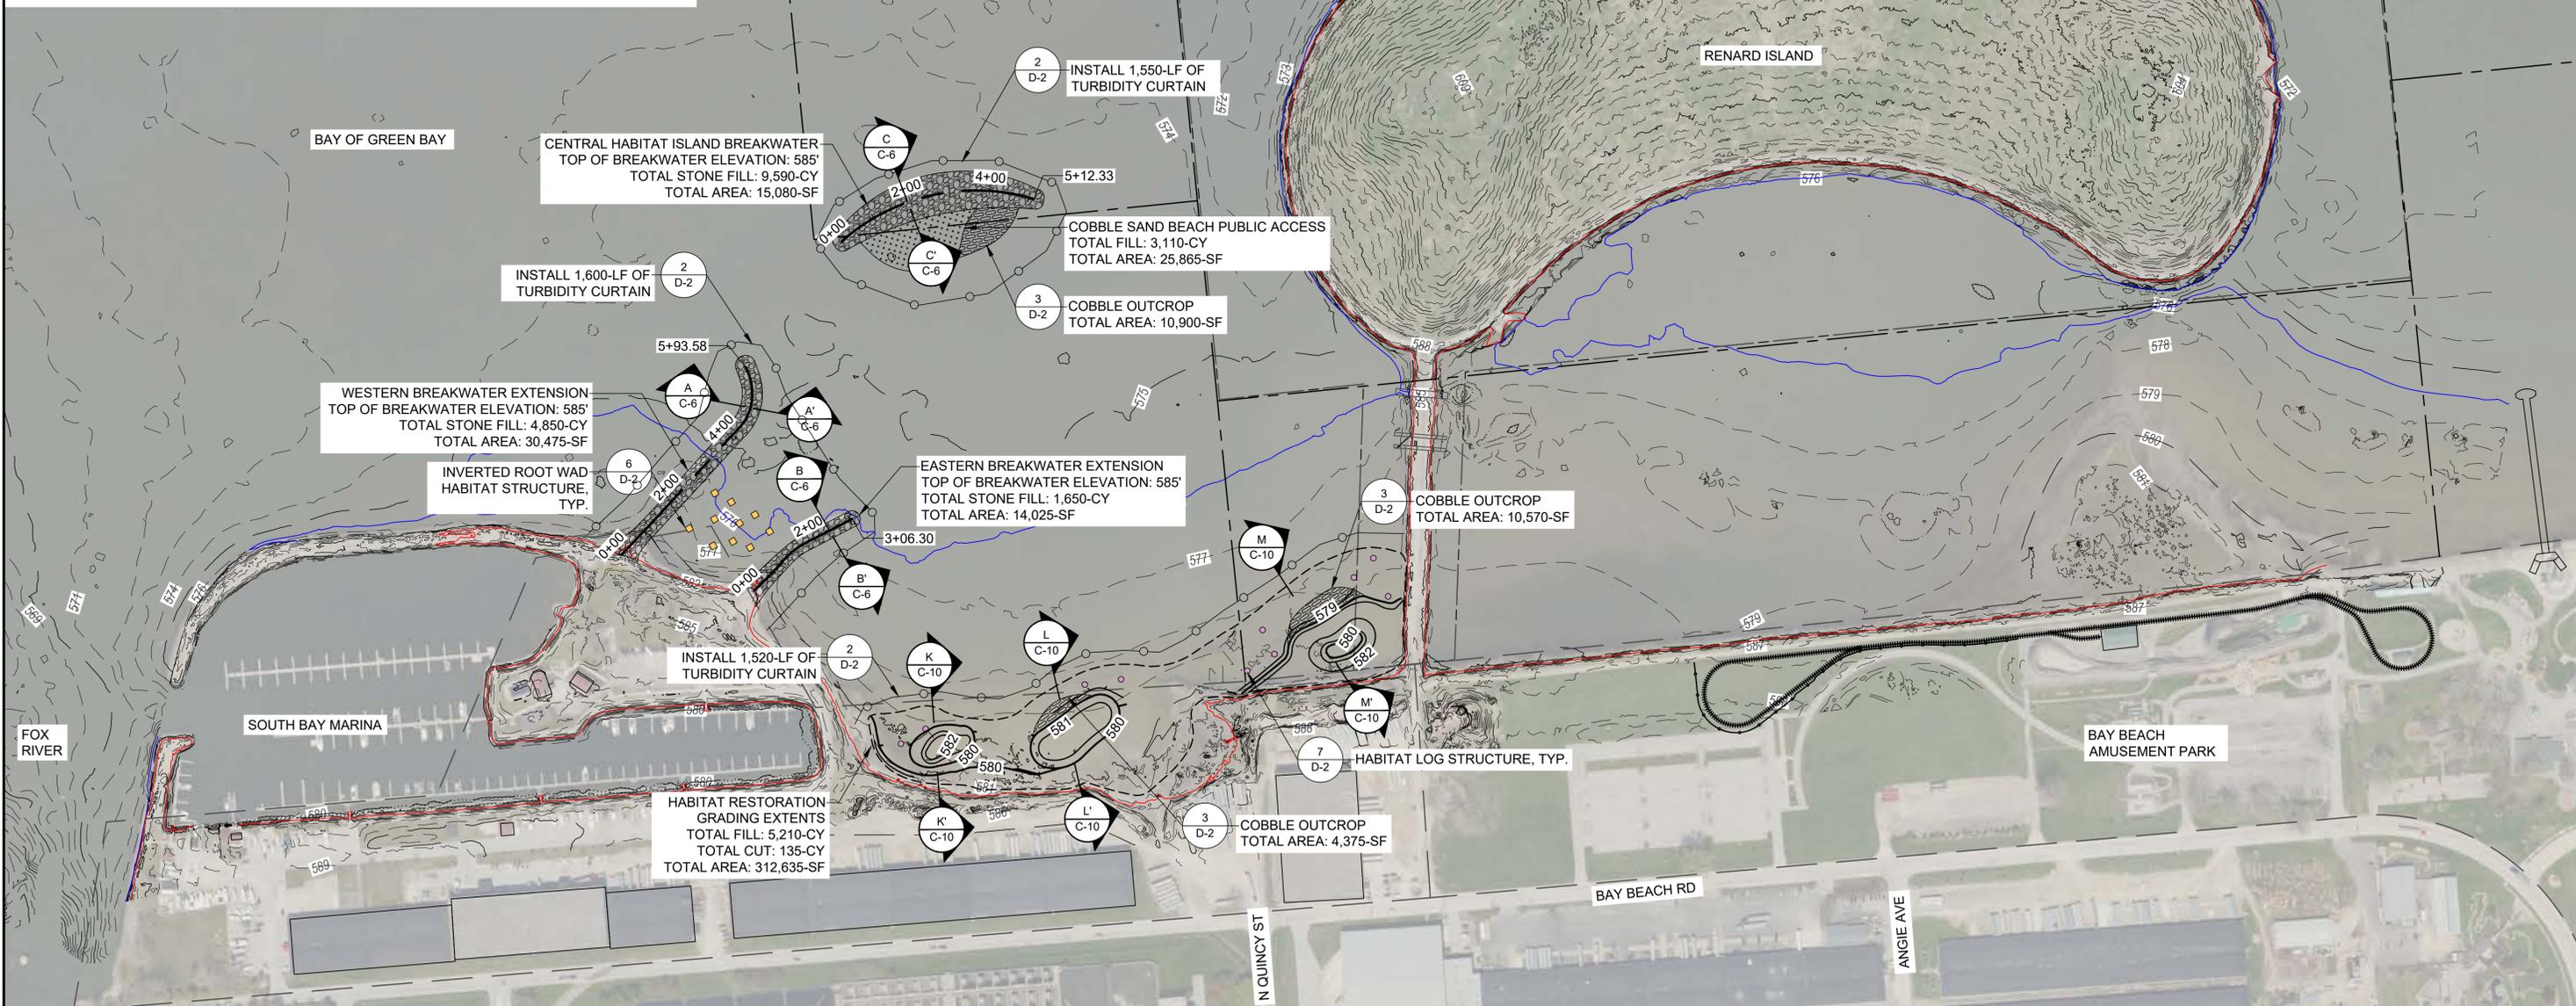
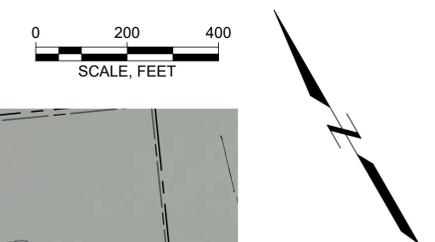
SHEET NAME
Phase 2B Breakwater and Habitat Restoration Grading Plan

SHEET NO.
16 OF 21

DWG. NO.
C-15

PROGRESS 60%

LEGEND	
	EXISTING MAJOR CONTOUR
	EXISTING MINOR CONTOUR
	PROPOSED MAJOR CONTOUR
	PROPOSED MINOR CONTOUR
	PROPOSED GRADING EXTENTS
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	PROPOSED COBBLE SAND BEACH
	PROPOSED INVERTED ROOT WAD
	PROPOSED HABITAT LOG STRUCTURE



LURD, ASHLEY | B:\Working\GREEN BAY WI CITY OF\2400860 McDonald NCRF Restoration\100_CAD\Design\Sheet\Layout\Plan_Phase 3.dwg - 9/29/2025

NOTES:
1. SEE HABITAT RESTORATION PLANTING PLAN ON SHEET C-13 FOR HABITAT PLANTING AREAS IN PHASE 3.

Attention:
0 1"

If this scale bar does not measure 1" then drawing is not original scale.

DRAFT

Designed:
Drawn:
Checked:
Approved:
P.E. No:
GEI Project 2400860

CITY OF GREEN BAY
100 N. JEFFERSON ST.
GREEN BAY, WI 54301

GREEN BAY MCDONALD NCRF RESTORATION PROJECT

GREEN BAY, WI 54302

NO	DATE	ISSUE/REVISION	APP
3	10/2/2025	60% DESIGN DRAFT	AT
2	3/11/2025	60% DESIGN DRAFT	AT
1	2/7/2025	PRELIMINARY DESIGN	AT

SHEET NAME
Phase 3 Breakwater and Habitat Restoration Grading Plan




SHEET NO.
17 OF 21

DWG. NO.
C-16

PROGRESS 60%

LEGEND

	EXISTING MAJOR CONTOUR
	EXISTING MINOR CONTOUR
	LOW WATER ELEVATION- 576'
	HIGH WATER ELEVATION- 583'
	FOX RIVER BULKHEAD
	PARCEL BOUNDARY
	TURBIDITY CURTAIN
	PROPOSED BREAKWATER STRUCTURE
	PROPOSED COBBLE SAND BEACH
	PROPOSED BOARDWALK AND GATHERING CIRCLE
	PROPOSED CONCRETE PAVED PATH
	FILL BEHIND SHEET PILE WALL

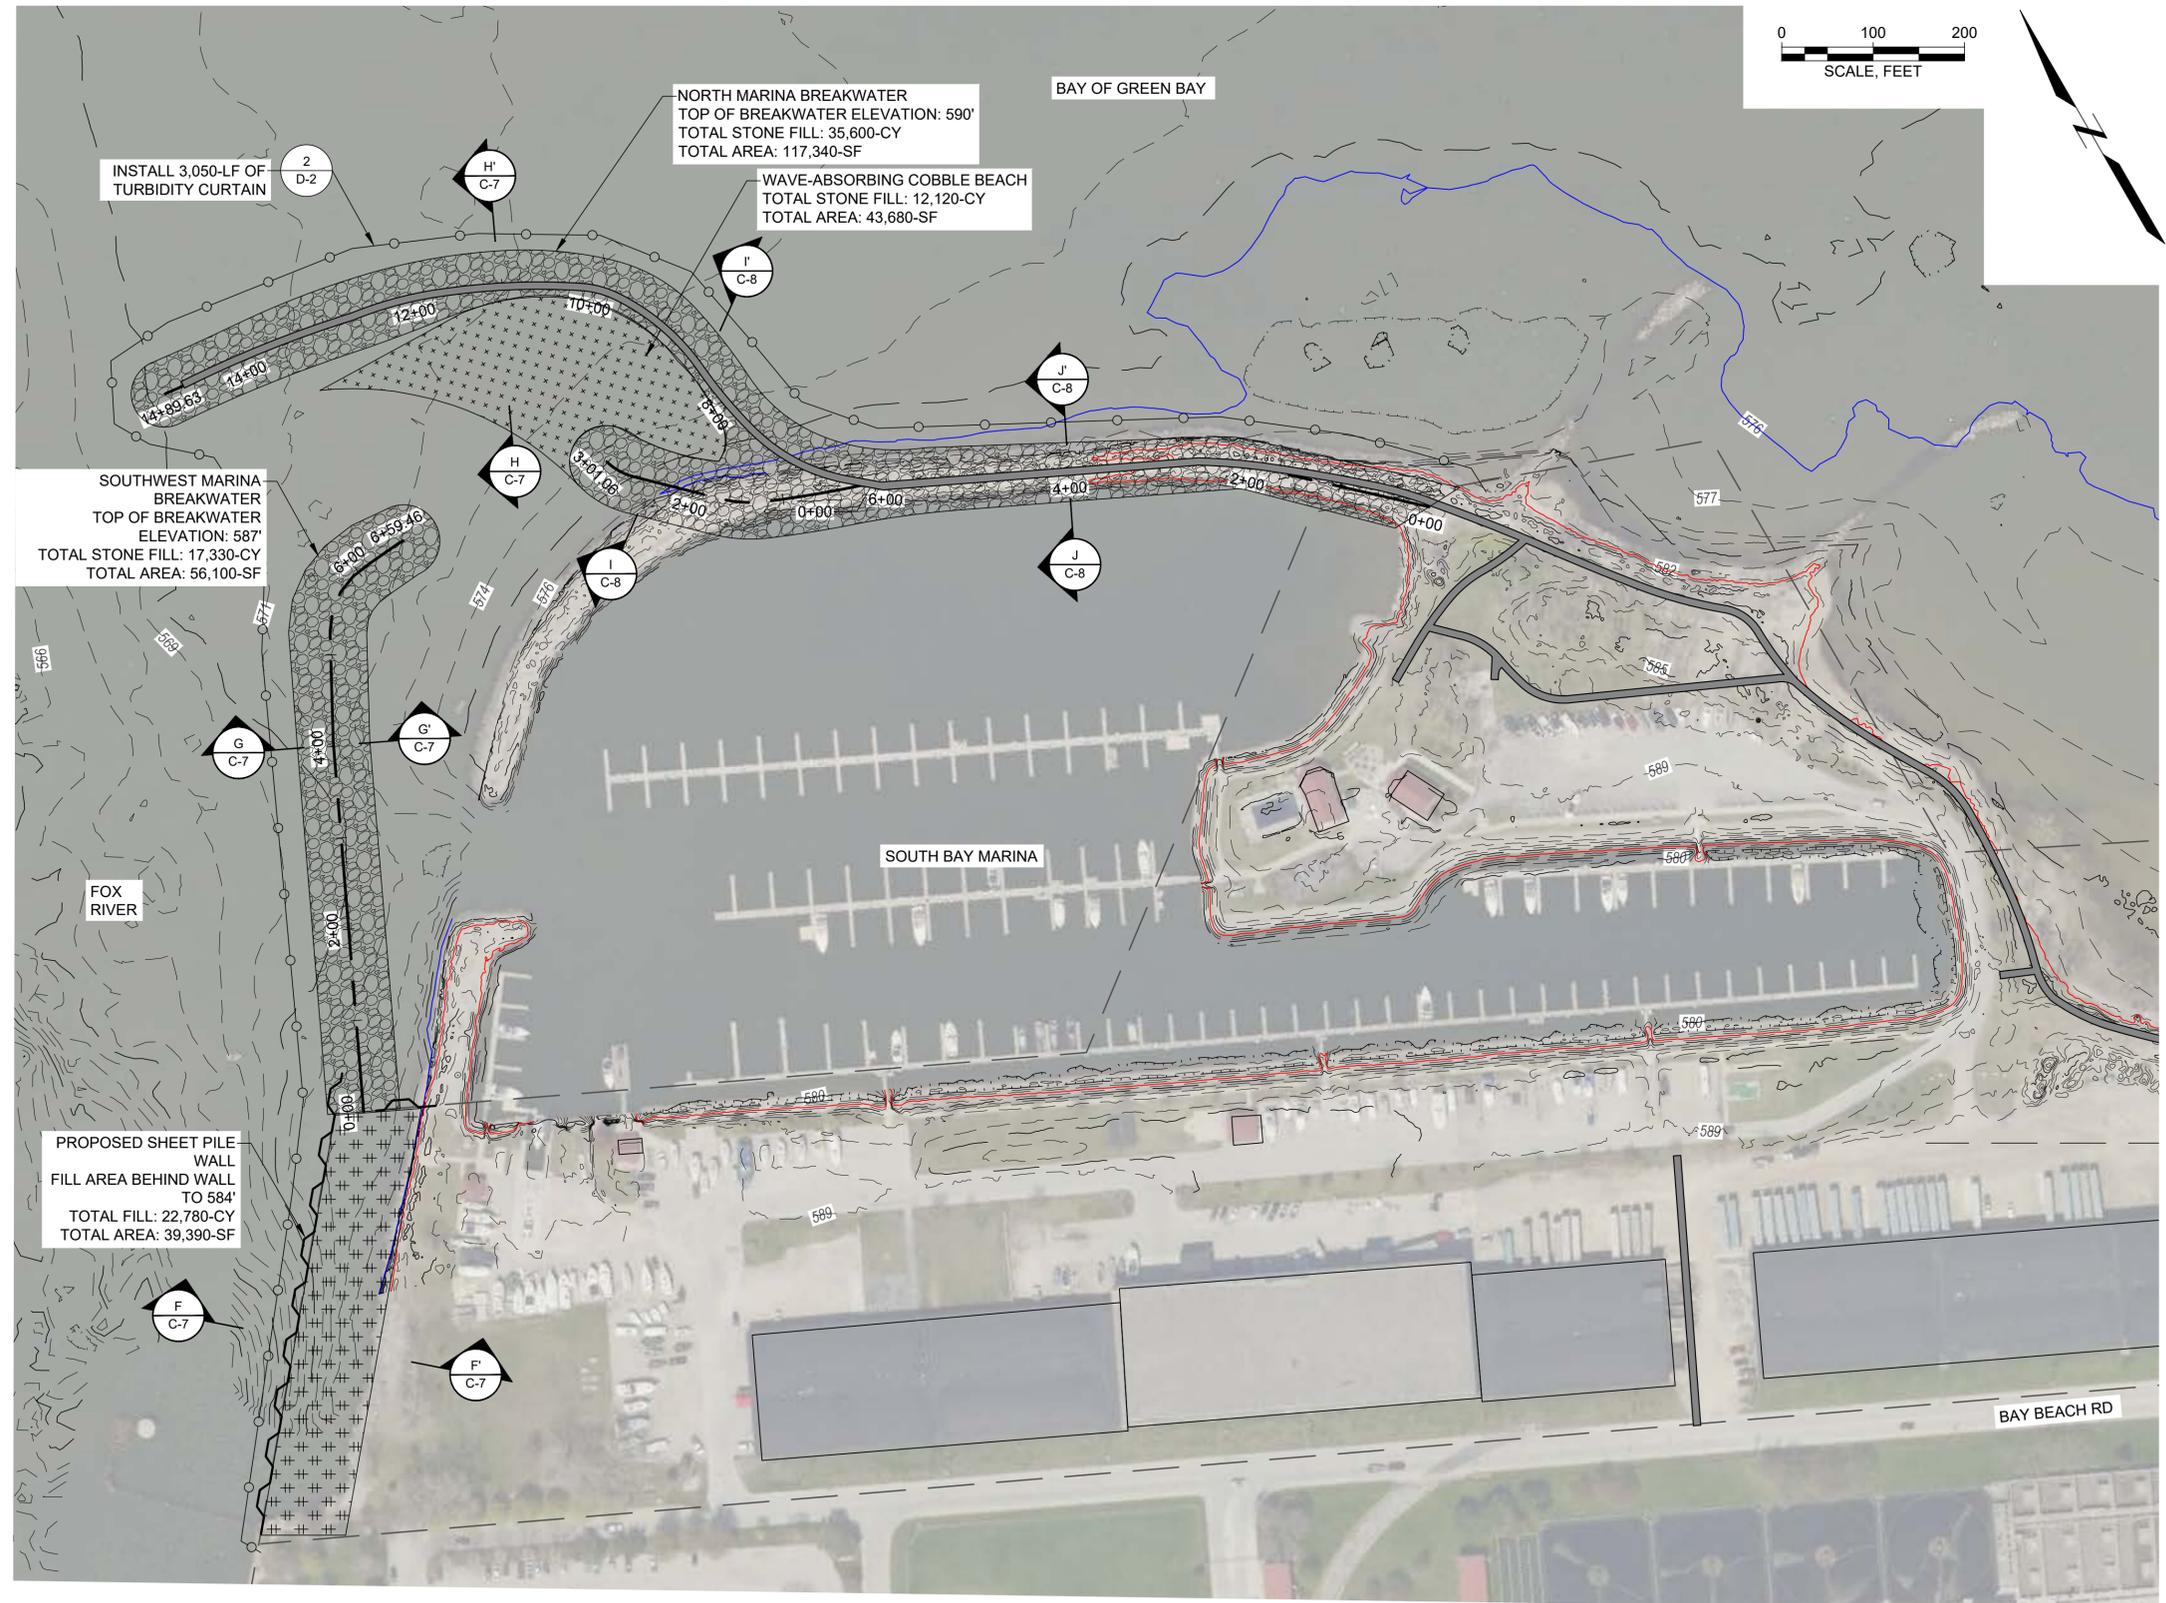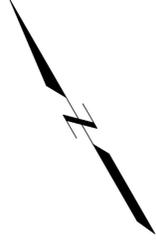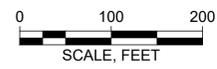

LUPRO, ASHLEY B:\Working\GREEN BAY WI CITY OF GREEN BAY\NCRF Restoration\100_McDonald NCRF Restoration\100_CAD\Design\Sheet\Marina Breakwater Plan_Phase 4.dwg - 02/20/2025

PROGRESS 60%

<p>Attention:</p> <p>If this scale bar does not measure 1" then drawing is not original scale.</p>	<p>DRAFT</p>	Designed:	<p>CITY OF GREEN BAY 100 N. JEFFERSON ST. GREEN BAY, WI 54301</p>	<p>GREEN BAY MCDONALD NCRF RESTORATION PROJECT</p>	<table border="1"> <tr><td> </td><td> </td><td> </td><td> </td></tr> <tr><td>3</td><td>10/2/2025</td><td>60% DESIGN DRAFT</td><td>AT</td></tr> <tr><td>2</td><td>3/11/2025</td><td>60% DESIGN DRAFT</td><td>AT</td></tr> <tr><td>1</td><td>2/7/2025</td><td>PRELIMINARY DESIGN</td><td>AT</td></tr> <tr><td>NO</td><td>DATE</td><td>ISSUE/REVISION</td><td>APP</td></tr> </table>																									3	10/2/2025	60% DESIGN DRAFT	AT	2	3/11/2025	60% DESIGN DRAFT	AT	1	2/7/2025	PRELIMINARY DESIGN	AT	NO	DATE	ISSUE/REVISION	APP	<p>SHEET NAME</p> <p>Phase 4 Marina Breakwater Plan</p>	<p>SHEET NO.</p> <p>19 OF 21</p>
3	10/2/2025	60% DESIGN DRAFT	AT																																												
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SUBMERGENT MARSH PLANT LIST:

SCIENTIFIC NAME	COMMON NAME	QTY
<i>Ceratophyllum demersum</i>	Coontail	2000
<i>Elodea canadensis</i>	Common Waterweed	1500
<i>Najas flexilis</i>	Slender Naiad	1300
<i>Nuphar advena</i>	Yellow Pond Lily	1800
<i>Nuphar variegata</i>	Bull-Headed Pond Lily	1500
<i>Nymphaea odorata</i>	American White Water Lily	1500
<i>Potamogeton gramineus</i>	Variable Leaf Pondweed	1500
<i>Potamogeton illinoensis</i>	Illinois pondweed	1300
<i>Potamogeton natans</i>	Floating-Leaf Pondweed	2000
<i>Potamogeton obtusifolius</i>	Blunt-Leaved Pondweed	2000
<i>Potamogeton richardsonii</i>	Richardson's Pondweed	1800
<i>Potamogeton robbinsii</i>	Robbin's Pondweed	1500
<i>Potamogeton zosteriformis</i>	Flat-Stem Pondweed	2000
<i>Stuckenia pectinata</i>	Sago Pondweed	1500
<i>Vallisneria americana</i>	Water-Celery	1800
	TOTAL	25000

EMERGENT MARSH PLANT LIST:

SCIENTIFIC NAME	COMMON NAME	QTY
<i>Alisma plantago-aquatica</i>	Water Plantain	1000
<i>Bolboschoenus fluviatilis</i>	River Bulrush	1000
<i>Campanula aparinoides</i>	Marsh Bellflower	1200
<i>Carex aquatilis</i>	Water Sedge	1300
<i>Carex comosa</i>	Bristly Sedge	1500
<i>Carex hystericina</i>	Porcupine Sedge	1500
<i>Carix lacustris</i>	Lake Sedge	2000
<i>Carex lasiocarpa</i>	Wiregrass Sedge	1300
<i>Ciruta bulbifera</i>	Water Hemlock	850
<i>Comarum palustre</i>	Marsh Cinquefoil	1000
<i>Deschampsia cespitosa</i>	Tufted Hairgrass	1300
<i>Eleocharis acicularis</i>	Needle Spike-Rush	1300
<i>Eleocharis elliptica</i>	Elliptic Spike-Rush	1300
<i>Eleocharis paulstris</i>	Common Spike-Rush	1500
<i>Eleocharis qunqueflora</i>	Few-Flowered Spike-Rush	1300
<i>Glyceria canadensis</i>	Rattlesnake Manna Grass	1500
<i>Glyceria grandis</i>	Reed Manna Grass	1500
<i>Juncus brevicaudatus</i>	Narrow-Panicled Rush	1000
<i>Juncus canadensis</i>	Canada Rush	1300
<i>Juncus effusus</i>	Common Rush	2000
<i>Leersia oryzoides</i>	Rice Cut Grass	1000
<i>Persicaria amphibia</i>	Water Smartweed	850
<i>Pontederia cordata</i>	Pickeral-Weed	1000
<i>Rumex orbiculatus</i>	Great Water Dock	1000
<i>Sagittaria latifolia</i>	Common Arrowhead	1500
<i>Schoenoplectus acutus</i>	Hardstem Bulrush	2000
<i>Schoenoplectus pungens</i>	Threesquare Bulrush	2000
<i>Schoenoplectus tabernamontani</i>	Softstem Bulrush	1300
<i>Scirpus atrovirens</i>	Dark Green Rush	1300
<i>Scirpus cyperinus</i>	Wood Grass	1000
<i>Scutellaria galericulata</i>	Common Skullcap	900
<i>Sparanium eurycarpum</i>	Common Bur-Reed	1500
	TOTAL	42000

WET MEADOW PLANT LIST:

SCIENTIFIC NAME	COMMON NAME	QTY
<i>Anemone canadensis</i>	Meadow Anemone	100
<i>Asclepias incarnata</i>	Marsh Milkweed	400
<i>Aster novae angliae</i>	New England Aster	500
<i>Aster puniceus</i>	Swamp Aster	250
<i>Bromus ciliatus</i>	Finged Brome	250
<i>Carex bebbii</i>	Bebb's Oval Sedge	500
<i>Carex crawfordii</i>	Carfod's Sedge	200
<i>Carex crinita</i>	Fringed Sedge	250
<i>Carex scoparia</i>	Lance-Fruited Oval Sedge	200
<i>Carex stipata</i>	Common Fox Sedge	500
<i>Carex vulpinoidea</i>	Brown Fox Sedge	500
<i>Cassia hebecarpa</i>	Wild Senna	100
<i>Elymus virginicus</i>	Virginia Wild Rye	250
<i>Eupatorium maculatum</i>	Spotted Joe Pye Weed	500
<i>Eupatorium perfoliatum</i>	Boneset	500
<i>Glyceria canadensis</i>	Rattlesnake Grass	150
<i>Glyceria grandis</i>	Reed Mana Grass	250
<i>Helenium autumnale</i>	Sneezeweed	400
<i>Heliopsis helianthoides</i>	Early Sunflower	100
<i>Liatris spicata</i>	Marsh Blazing Star	150
<i>Lobelia siphilitica</i>	Great Blue Lobelia	500
<i>Mimulus ringens</i>	Monkey Flower	150
<i>Monarda fistulosa</i>	Wild Bergamot	500
<i>Parthenium integrifolium</i>	Wild Quinine	100
<i>Pycnanthemum virginianum</i>	Mountain Mint	150
<i>Ratibida pinnata</i>	Yellow Coneflower	500
<i>Scirpus pendulus</i>	Red Bulrush	400
<i>Silphium terebinthinaceum</i>	Prairie Dock	200
<i>Solidago graminifolia</i>	Grass-Leaved Goldenrod	200
<i>Solidago ohioensis</i>	Ohio Goldenrod	150
<i>Solidago riddellii</i>	Riddell's Goldenrod	250
<i>Verbena hastata</i>	Blue Vervain	250
<i>Veronicastrum virginicum</i>	Culver's Root	200
<i>Zizia aurea</i>	Golden Alexanders	400
	TOTAL	10000

SHRUB CARR PLANT LIST:

SCIENTIFIC NAME	COMMON NAME	QTY
<i>Cornus amomum</i>	Silky Dogwood	2500
<i>Cornus sericea</i>	Red-Osier Dogwood	3500
<i>Ribes americanum</i>	Wild Black Currant	2500
<i>Salix bebbiana</i>	Bebb's Willow	2000
<i>Salix discolor</i>	Pussy Willow	3000
<i>Salix petiolaris</i>	Meadow Willow	2500
<i>Sambucus canadensis</i>	Elderberry	2500
<i>Spirea alba</i>	Meadowsweet	2500
	TOTAL	21000

GREAT LAKES BEACH PLANT LIST:

SCIENTIFIC NAME	COMMON NAME	QTY
<i>Achillea millefolium</i>	Common Yarrow	250
<i>Ageratina altissima</i>	White Snakeroot	250
<i>Asclepias syriaca</i>	Common Milkweed	500
<i>Bolboschoenus fluviatilis</i>	River Bulrush	750
<i>Eleocharis palustris</i>	Common Spike-Rush	250
<i>Eupatorium perfoliatum</i>	Boneset	250
<i>Juncus dudleyi</i>	Dudley's Rush	500
<i>Lycopus americanus</i>	American Water-Horehound	250
<i>Mimulus ringens</i>	Allegheny Monkey-Flower	250
<i>Potentilla anserina</i>	Silver-Weed	250
<i>Poa palustris</i>	Fowl Meadow Grass	500
<i>Rorippa palustris</i>	Bog Yellow-Cress	250
<i>Schoenoplectus acutus</i>	Hard-Stem Bulrush	750
<i>Schoenoplectus pungens</i>	Threesquare Bulrush	1000
<i>Solidago canadensis</i>	Canadian Goldenrod	250
<i>Solidago gigantea</i>	Giant Goldenrod	500
<i>Verbena hastata</i>	Blue Vervain	250
	TOTAL	7000

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PROGRESS 60%

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		Drawn:									
		Checked:									
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		P.E. No:									
		GEI Project 2400860		GREEN BAY, WI 54302						DWG. NO. D-1	
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